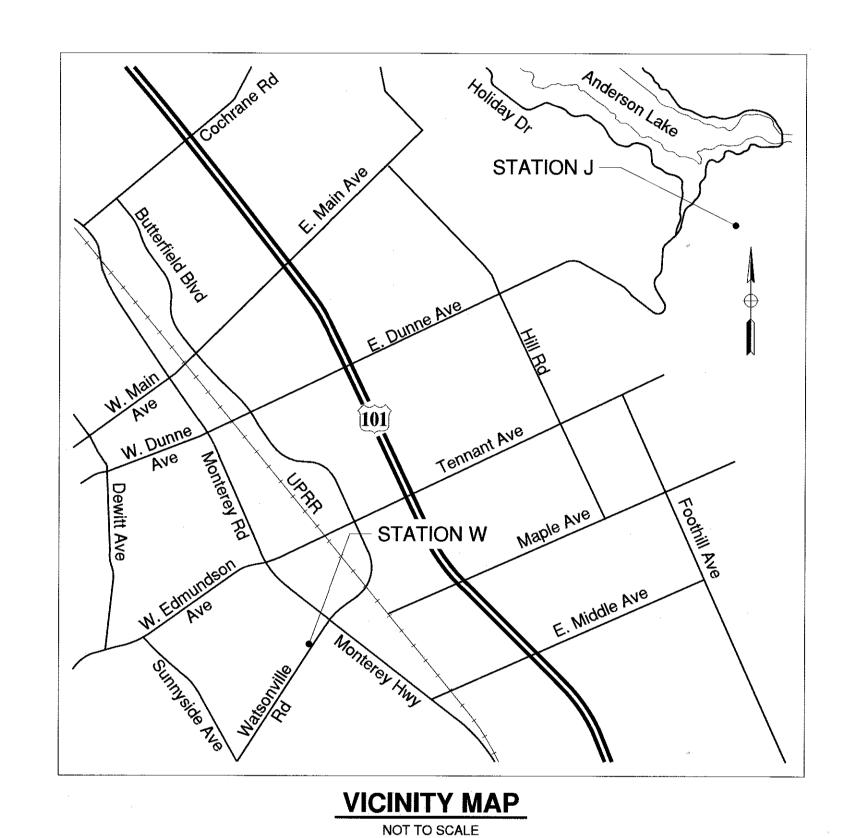
IMPROVEMENT PLANS FOR

SANITARY SEWER LIFT STATIONS J & W REHABILITATION

Station J: 16035 Jackson Oaks Drive Station W: 15505 Watsonville Road

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STATION J SITE CONTROL

STATION J SITE CONTROL IS BASED ON A DECEMBER 2015 TOPOGRAPHIC SURVEY E MH ENGINEERING CO. COORDINATES SHOWN ARE BASED ON A LOCAL COORDINATE SYSTEM ESTABLISHED BY THE SURVEY.

BENCHMAR

THE SITE BENCHMARK ELEVATION FOR STATION J IS A POINT ON THE NORTHERN MOS CORNER OF THE EXISTING STORM DRAIN INLET RIM.


ELEVATION = 999.35 (N 5533.51, E 5373.52

BASIS OF BEARIN

HE BASIS OF BEARING FOR STATION J IS A LINE WITH A BEARING OF N 6°7'40" E WITH A ENGTH OF 325 FEET FROM POINT A TO POINT B.

POINT A IS A "BPM" AT THE INTERSECTION OF THE CENTERLINE OF OAKRIDGE ROAD WITH THE CENTERLINE OF JACKSON OAKS DRIVE WITH COORDINATES OF N 5000.00, E 5000.00.

POINT B IS A POINT ALONG THE CENTERLINE OF OAKRIDGE ROAD WITH COORDINATES OF N 5323.14, E 5034.69.

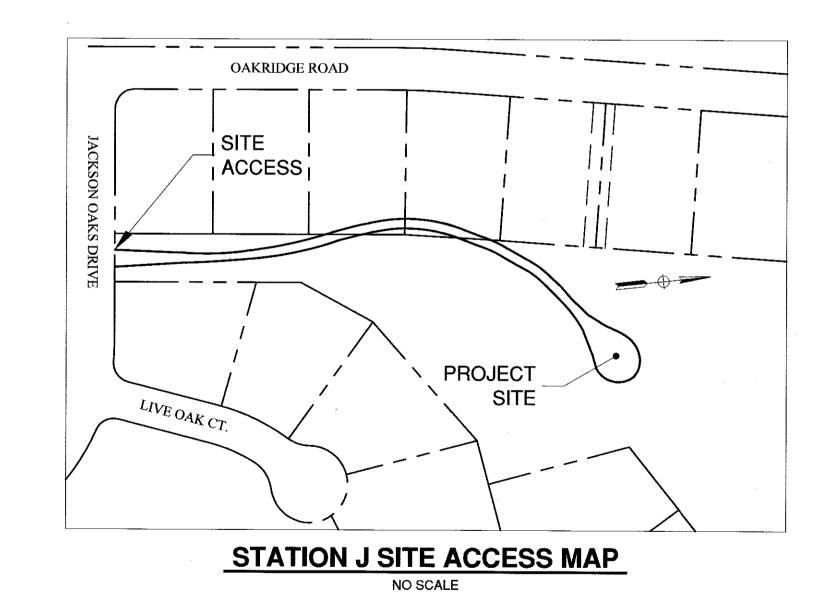

PREPARED BY:

LOGAN N. FOX SCHAAF & WHEELER



DATE: 2/16/18

CONTRACTOR AGREES THAT HE SHALL ASSUME SOLE AND COMPLETE RESPONSIBILITY FOR JOB SITE CONDITIONS DURING THE COURSE OF CONSTRUCTION OF THIS PROJECT, INCLUDING SAFETY OF ALL PERSONS AND PROPERTY; THAT THIS REQUIREMENT SHALL APPLY CONTINUOUSLY AND NOT BE LIMITED TO NORMAL WORKING HOURS; AND THAT THE CONTRACTOR SHALL DEFEND, INDEMNIFY, AND HOLD THE OWNER AND THE ENGINEER HARMLESS FROM ANY AND ALL LIABILITY, REAL OR ALLEGED, IN CONNECTION WITH THE PERFORMANCE OF WORK ON THIS PROJECT, EXCEPTING FOR LIABILITY ARISING FROM THE SOLE NEGLIGENCE OF THE OWNER OR THE ENGINEER.

NITARY SEWER LIFT STAT

DATE VERT

DATE JOB NUMBER

//// # MHIL.21.15

| CHECKED | CHECKED | CAN | CA

City of Mor of Morgan Hill, CA 95037 (408)778-6480

DATE BY

NO

NO. DESCRIPTIONS

FILE NUMBER:
PRINT DATE:
2/16/2018

SHEET NUMBER:

GENERAL

- 1. CONTRACTOR SHALL NOTIFY THE UNDERGROUND SERVICE ALERT @ 1-800-642-2444 48 HOURS PRIOR TO COMMENCEMENT OF EXCAVATION.
- 2. LOCATIONS AND DEPTHS OF EXISTING UNDERGROUND PIPELINES ARE APPROXIMATE. CONTRACTOR IS RESPONSIBLE FOR EXACT FIELD LOCATIONS. A MINIMUM OF 6 INCHES VERTICAL CLEARANCE BETWEEN PIPES CROSSING UNDERGROUND SHALL BE MAINTAINED WHETHER SHOWN ON DRAWINGS OR NOT. ANY CONFLICTS IN PIPING SHALL BE IMMEDIATELY BROUGHT TO THE ATTENTION OF THE ENGINEER.
- 3. PIPELINES SHALL SLOPE UNIFORMLY BETWEEN ELEVATIONS SHOWN ON PLANS. UNLESS OTHERWISE NOTED, ALL PIPE ELEVATIONS SHOWN REFER TO THE INVERT.
- 4. ALL SANITARY SEWERS SHALL BE CONSTRUCTED IN ACCORDANCE WITH CITY OF MORGAN HILL STANDARD DETAILS. MATERIALS SHALL CONFORM TO THE AMERICAN SOCIETY OF TESTING AND MATERIALS (ASTM), AND AMERICAN WATER WORKS ASSOCIATION (AWWA), EXCEPT AS MODIFIED HEREIN.
- 5. SANITARY SEWER GRAVITY LINES SHALL BE PVC PIPE ASTM 3034-SDR26. SANITARY FORCE MAIN SHALL BE PVC PIPE AWWA C900.
- 6. ALL DIRECTIONS, EXCEPT FOR THE CONTROL LINE, ARE GIVEN IN AZIMUTHS WHICH ARE MEASURED IN A CLOCKWISE DIRECTION FROM 0° NORTH. ROAD CENTERLINES ARE GIVEN AS BEARINGS.
- 7. CONSTRUCTION SHALL BE IN CONFORMANCE W/ MANUFACTURERS' RECOMMENDATIONS.
- 8. THE CONTRACTOR SHALL BE RESPONSIBLE FOR MAINTAINING AS-BUILT DRAWINGS. DRAWINGS SHALL RECORD THE APPROVED CHANGES MADE IN ACTUAL CONSTRUCTION FROM CONTRACT PLANS.

CONSTRUCTION WITHIN CITY RIGHT-OF-WAY

- 1. NO PERSON OR CONTRACTOR SHALL PERFORM ANY IMPROVEMENT OR ENCROACHMENT WORK OF ANY KIND IN ANY PUBLIC RIGHT-OF-WAY WITHIN THE CITY WITHOUT FIRST HAVING OBTAINED AN ENCROACHMENT PERMIT FROM THE PUBLIC WORKS DEPARTMENT.
- 2. CONTRACTOR SHALL ARRANGE FOR A PRE-CONSTRUCTION MEETING WITH THE CITY ENGINEER (MUNICIPAL CODE 17.32.250b) PRIOR TO COMMENCING ANY CONSTRUCTION. AN ENCROACHMENT PERMIT SHALL BE OBTAINED FROM THE PUBLIC WORKS DEPARTMENT UPON COMPLETION OF SAID MEETING AND PRIOR TO CONSTRUCTION OF ANY IMPROVEMENTS WITHIN AN EXISTING OR OFFERED FOR DEDICATION RIGHT-OF- WAY, PUBLIC UTILITY EASEMENT OR PUBLIC SERVICE
- 3. CONTRACTOR SHALL NOTIFY THE PUBLIC WORKS DEPARTMENT 48 HOURS PRIOR TO COMMENCEMENT OF ANY WORK PHASE. AT THAT TIME AN "INSPECTION REQUEST FORM" SHALL BE COMPLETED TO ENSURE PROPER SCHEDULING OF AN INSPECTION WITH THE CITY ENGINEER'S REPRESENTATIVE.
- 4. CONTRACTOR SHALL NOT DESTROY EXISTING PERMANENT SURVEY MONUMENTS: WHETHER PROPERTY CORNERS OR STREET CENTERLINE MONUMENTS.
- 5. ALL WORK SHALL CONFORM TO THE LATEST EDITION OF THE MORGAN HILL STANDARD DETAILS FOR CONSTRUCTION. DEVIATIONS FROM THE STANDARD DETAILS MUST BE APPROVED BY THE CITY ENGINEER.
- 6. CONTRACTOR SHALL ONLY USE EQUIPMENT PROVIDED WITH A SPARK ARRESTOR DEVICE TO REDUCE A POTENTIAL FIRE HAZARD.
- 7. CONTRACTOR SHALL PRESERVE ALL SURROUNDING PROPERTY BY CONFINING OPERATIONS TO WITHIN THE "LIMITS OF WORK". CONTRACTOR SHALL BE RESPONSIBLE FOR MAINTAINING ACCESS FOR ALL ADJOINING RESIDENTS. PLACES OF BUSINESS, AND PROPERTIES AT ALL TIMES AND IN A SAFE MANNER. CONTRACTOR SHALL MAKE PROPER NOTIFICATION AT LEAST 24 HOURS IN ADVANCE OF ANY INTERRUPTION IN ACCESS OR SERVICE TO THE ABOVE PROPERTY OWNERS AS WELL AS TO THE CITY ENGINEER'S REPRESENTATIVE.
- . CONTRACTOR WILL BE ALLOWED TO DRAW WATER FROM THE CITY OF MORGAN HILL WATER DISTRIBUTION SYSTEM ONLY AFTER OBTAINING A HYDRANT METER FROM THE PUBLIC WORKS DEPARTMENT AND AN INSPECTION OF THE WATER TRUCK FOR A PROPER BACKFLOW DEVICE OR "AIR-GAP" FILLING PIPE. CONTRACTOR SHALL KEEP DOWN DUST FROM CONSTRUCTION ACTIVITY TO THE MAXIMUM EXTENT POSSIBLE. CONTRACTOR SHALL CLEAN ALL EXISTING STREETS. CURBS, GUTTERS, AND SIDEWALKS AFFECTED BY THE PROJECT AT THE END OF EACH WORKING DAY. THE WATER SERVICE LOCATED AT THE LIFT STATION M SITE IS AVAILABLE TO THE CONTRACTOR.

MATERIAL STORAGE

9. NO MATERIAL SHALL BE STORED NEAR THE EDGE OF PAVEMENT, TRAVELED WAY, SIDEWALK, DRIVEWAY, OR SHOULDER LINE WHICH MAY CREATE A HAZARD FOR VEHICULAR AND PEDESTRIAN TRAFFIC.

TRAFFIC CONTROL

PATH

10. CONTRACTOR SHALL SUBMIT A TRAFFIC CONTROL PLAN FOR APPROVAL TO THE PUBLIC WORKS DEPARTMENT A MINIMUM OF 5 DAYS PRIOR TO ANY WORK WITHIN AN EXISTING PUBLIC STREET. THE PLAN SHALL BE SIGNED BY A LICENSED TRAFFIC ENGINEER WHEN IT INVOLVES AN ARTERIAL STREET. CONTRACTOR SHALL PROVIDE ALL NECESSARY TRAFFIC CONTROL IN ACCORDANCE WITH THE LATEST EDITION OF CALTRANS "MANUAL FOR WARNING SIGNS, LIGHTS, AND DEVICES FOR USE IN PERFORMANCE OF WORK UPON HIGHWAYS" WHILE WORKING WITHIN THE PUBLIC RIGHT-OF-WAY. TWO TRAFFIC LANES (10' MIN) SHALL BE OPEN TO VEHICULAR TRAFFIC DURING ALL HOURS, WEEKENDS, AND HOLIDAYS. ONE LANE ONE WAY TRAFFIC, MAY BE UNDER THE CONTROL OF NOT LESS THAN 2 (TWO) COMPETENT FLAGMEN DURING CONSTRUCTION OPERATIONS. STREET CLOSURES AND DETOURS SHALL ONLY TAKE PLACE UPON CITY ENGINEER APPROVAL AND POLICE DEPARTMENT COORDINATION.

WORK ACCEPTED: INSPECTOR:

TRENCH EXCAVATION

11. CONTRACTOR SHALL EXERCISE DILIGENCE IN REVIEWING AVAILABLE RESOURCES TO FAMILIARIZE THEMSELVES WITH THE SOIL CONDITIONS TO BE ENCOUNTERED IN THE COURSE OF WORK IDENTIFIED IN THESE PLANS. CONTRACTOR SHALL NOT CAUSE DAMAGE TO ADJACENT TREES OR EXISTING STRUCTURES ABOVE OR BELOW GRADE DURING TRENCH EXCAVATION. ALL ROCKS, BOULDERS, AND LARGE STONES ENCOUNTERED SHALL BE REMOVED TO PROVIDE A CLEARANCE OF 6 INCHES AROUND THE PIPE. THE TRENCH BOTTOM SHALL BE REFILLED TO GRADE WITH SAND OR OTHER APPROVED GRANULAR MATERIAL. IF THE BOTTOM OF THE TRENCH IS FOUND TO CONSIST OF WET OR UNSTABLE MATERIAL INCAPABLE OF PROPERLY SUPPORTING THE PIPE, THE MATERIAL SHALL BE REMOVED TO A MINIMUM DEPTH OF 12 INCHES BELOW THE UNSTABLE LAYER FOR THE FULL WIDTH OF THE TRENCH AND REPLACED WITH APPROVED GRANULAR MATERIAL. TRENCH EXCAVATION MATERIAL DEPOSITED ADJACENT TO THE TRENCH SHALL BE PLACED AND LOCATED TO PREVENT SPILLAGE INTO THE OPEN TRENCH.

TRENCH SAFETY

- 12. IT SHALL BE CONTRACTOR'S RESPONSIBILITY TO PROVIDE ALL NECESSARY TRENCH SAFETY MEASURES FOR EXCAVATIONS. ALL TRENCH SAFETY MEASURES SHALL BE IN ACCORDANCE WITH THE LATEST CAL-OSHA GUIDELINES. CONTRACTOR SHALL PROVIDE EVIDENCE OF A CAL-OSHA TRENCHING PERMIT AT THE PRE-CONSTRUCTION MEETING.
- 13. EXCAVATIONS WITHIN THE PUBLIC TRAVELED WAY SHALL BE BACKFILLED, COMPACTED, AND TEMPORARILY PAVED WITH COLD MIX "CUT BACK" TYPE A.C. TO ALLOW FOR VEHICULAR AND PEDESTRIAN TRAFFIC PRIOR TO 4:00 P.M. THE USE OF TRENCH PLATES IS ALLOWED, PROVIDED THE CONTRACTOR COVERS ALL EDGES OF THE PLATES WITH COLD MIX MATERIAL. IT SHALL BE THE CONTRACTORS RESPONSIBILITY TO MAINTAIN ON A DAILY BASIS, INCLUDING WEEKENDS, THE AMOUNT OF MATERIAL NECESSARY TO MAINTAIN THE TRENCH SURFACE FLUSH WITH THE EXISTING STREET OR SIDEWALK. IN ADDITION, THE CONTRACTOR SHALL RESPOND TO AND CORRECT SHIFTING TRENCH PLATES REGARDLESS OF THE TIME OF DAY. IF CONTRACTOR FAILS TO CORRECT SINKING BACKFILL MATERIAL OR SHIFTING TRENCH PLATES IN A TIMELY MANNER, CITY SHALL RESERVE THE RIGHT TO CORRECT THE PROBLEM AND BACK CHARGE THE CONTRACTOR.

JOINING EXISTING PAVEMENT

14. EXISTING PAVEMENT WHICH IS TO BE JOINED BY NEW PAVEMENT SHALL BE SAW CUT VERTICAL TO PROVIDE STRAIGHT, TRUE, AND NEAT JOINTS. OVERLAPPING OF EXISTING PAVEMENT WITHOUT SAW CUTTING OR GRINDING SHALL NOT BE PERMITTED. THE VERTICAL EDGES SHALL BE TACKED PRIOR TO PAVING. TERMINALS OF ALL SURFACING INDICATED ON THE PLANS SHALL JOIN ANY EXISTING SURFACE IN A SMOOTH BUTT JOINT. CONFORM PAVING BY METHOD OF ABRASIVE GRINDING WILL BE ALLOWED UPON APPROVAL OF THE CITY

SANITARY SEWER

- 15. SANITARY SEWER MANHOLES SHALL CONFORM TO THE CITY'S LATEST
- 16. PRECAST MANHOLE SECTIONS SHALL BE SEALED AT THE JOINTS WITH RAM-NEK.
- CONTRACTOR MAY USE PRECAST MANHOLE BASES.

WATER LINES

18. CONTRACTOR SHALL NOT TURN OFF OR ON ANY VALVES BELONGING TO THE CITY'S WATER SYSTEM. ONLY DEPARTMENT OF PUBLIC WORKS PERSONNEL SHALL OPEN THE NECESSARY VALVES TO CONNECT NEW LINES. FAILURE TO FOLLOW THIS REQUIREMENT SHALL BE CONSIDERED AN "UNLAWFUL CONNECTION" AND MAY RESULT IN ISSUING OF A CITATION AND FINES AS SPECIFIED IN SECTION 13.04 OF THE MORGAN HILL MUNICIPAL CODE.

STORM DRAINS

19. STORM DRAINS SHALL BE HDPE PIPE CONFORMING TO AASHTO M294 TYPE D OR TYPE S.

BACKFILL & COMPACTION

- 20. JETTING AND/OR FLOODING OF TRENCH BACKFILL MATERIAL WILL BE PERMITTED ONLY IF APPROVED BY THE SOILS ENGINEER AND CITY ENGINEER.
- 21. ANY EXCESS EXCAVATION MATERIAL SHALL BE REMOVED FROM PROJECT AREA AND DISPOSED.
- 22. THE MINIMUM RELATIVE COMPACTION FOR TRENCH BACKFILL, SUBGRADE AND BASE MATERIAL SHALL BE 95 % THROUGHOUT THE PROJECT APPROVED BY THE CITY ENGINEER, IN ACCORDANCE W/ CITY OF MORGAN HILL STANDARDS.
- 23. ANY AGGREGATE BASE THAT BECOMES CONTAMINATED DURING CONSTRUCTION SHALL BE REMOVED AND REPLACED WITH UNCONTAMINATED BASE.

STORMWATER MANAGEMENT EXEMPTION

24. IN ACCORDANCE WITH PROVISION E.12.k, THE CENTRAL COAST POST-CONSTRUCTION REQUIREMENTS, OF THE PHASE II PERMIT AND THE REGIONAL WATER QUALITY CONTROL BOARD REGION 3'S RESOLUTION R3-2013-0032, THIS PROJECT IS EXEMPT FROM POST-CONSTRUCTION PERFORMANCE REQUIREMENTS.

NEW/REPLACEMENT IMPERVIOUS QUANTITY (SF)					
LIFT STATION J	1,380				
LIFT STATION W	120				

LEGEND

PROPOSED EXISTING DESCRIPTION SANITARY SEWER -----SSFM-----SANITARY SEWER FORCE MAIN STORM DRAIN WATER MAIN ELECTRIC FENCE FENCE **EDGE OF PAVEMENT** REMOVE OR ABANDON RIGHT-OF-WAY CENTERLINE EASEMENT _____ GRADE BREAK CENTERLINE

SLOPE

ABBREVIATIONS


AB	AGGREGATE BASE	MIN	MINIMUM
AC	ASPHALTIC CONCRETE	MJ	MECHANICAL JOINT
ACP	ASBESTOS CEMENT PIPE	N	NORTHING
CATV	CABLE TELEVISION	(N)	NEW
CL	CENTER LINE	N.T.S.	NOT TO SCALE
CLR	CLEAR	oc	ON CENTER
CMP	CORRUGATED METAL PIPE	PCC	PORTLAND CEMENT CONCRETE
DIP	DUCTILE IRON PIPE	PE	PLAIN END
D/S	DOWNSTREAM	PUE	PUBLIC UTILITY EASEMENT
E	EASTING, ELECTRIC	PVC	POLYVINYL CHLORIDE
(E)	EXISTING	REQ'D	REQUIRED
EL	ELEVATION	RT	RIGHT
ELL	ELBOW	SF	SQUARE FEET
EP	EDGE OF PAVEMENT	SS	SANITARY SEWER, STAINLESS STEE
EQ	EQUAL	SSCO	SANITARY SEWER CLEANOUT
FG	FINISH GRADE	SSFM	SANITARY SEWER FORCE MAIN
FL	FLANGE	SSMH	SANITARY SEWER MANHOLE
FM	FORCEMAIN	STA	STATION
G	GAS	STL	STEEL
HDPE	HIGH DENSITY POLYETHYLENE	SD	STORM DRAIN
INV	INVERT	TC	TOP OF CURB
LF	LINEAR FEET	TYP	TYPICAL
LT	LEFT	VCP	VITRIFIED CLAY PIPE
MAX	MAXIMUM	W	WATER
MH	MANHOLE	WM	WATER METER

AS SHOWN AS SHOWN JOB NUMBER:

City of Morgan Hill

Schaaf & Wheeler CONSULTING CIVIL ENGINEERS 1171 HOMESTEAD ROAD, STE 255 SANTA CLARA, CA 95050

(408) 246-4848

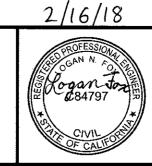

NOTES & ABBREVIATIONS

J & W REHABILITATION

PRINT DATE: 2/16/2018 SANITARY SEWER LIFT STATIONS SHEET NUMBER: 2 of 25


AS-BUILT CORRECTIONS **Public Works Department** APPROVED: BY BY: CITY OF MORGAN HILL DESCRIPTION DATE DATE: MHIL.21.15 100 Edes Ct. Morgan Hill, CA 95037 (408)778-6480, Fax (408)779-7236 REVISIONS CITYENGR SCOTT CREER


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CHECKED:

FILE NUMBER:



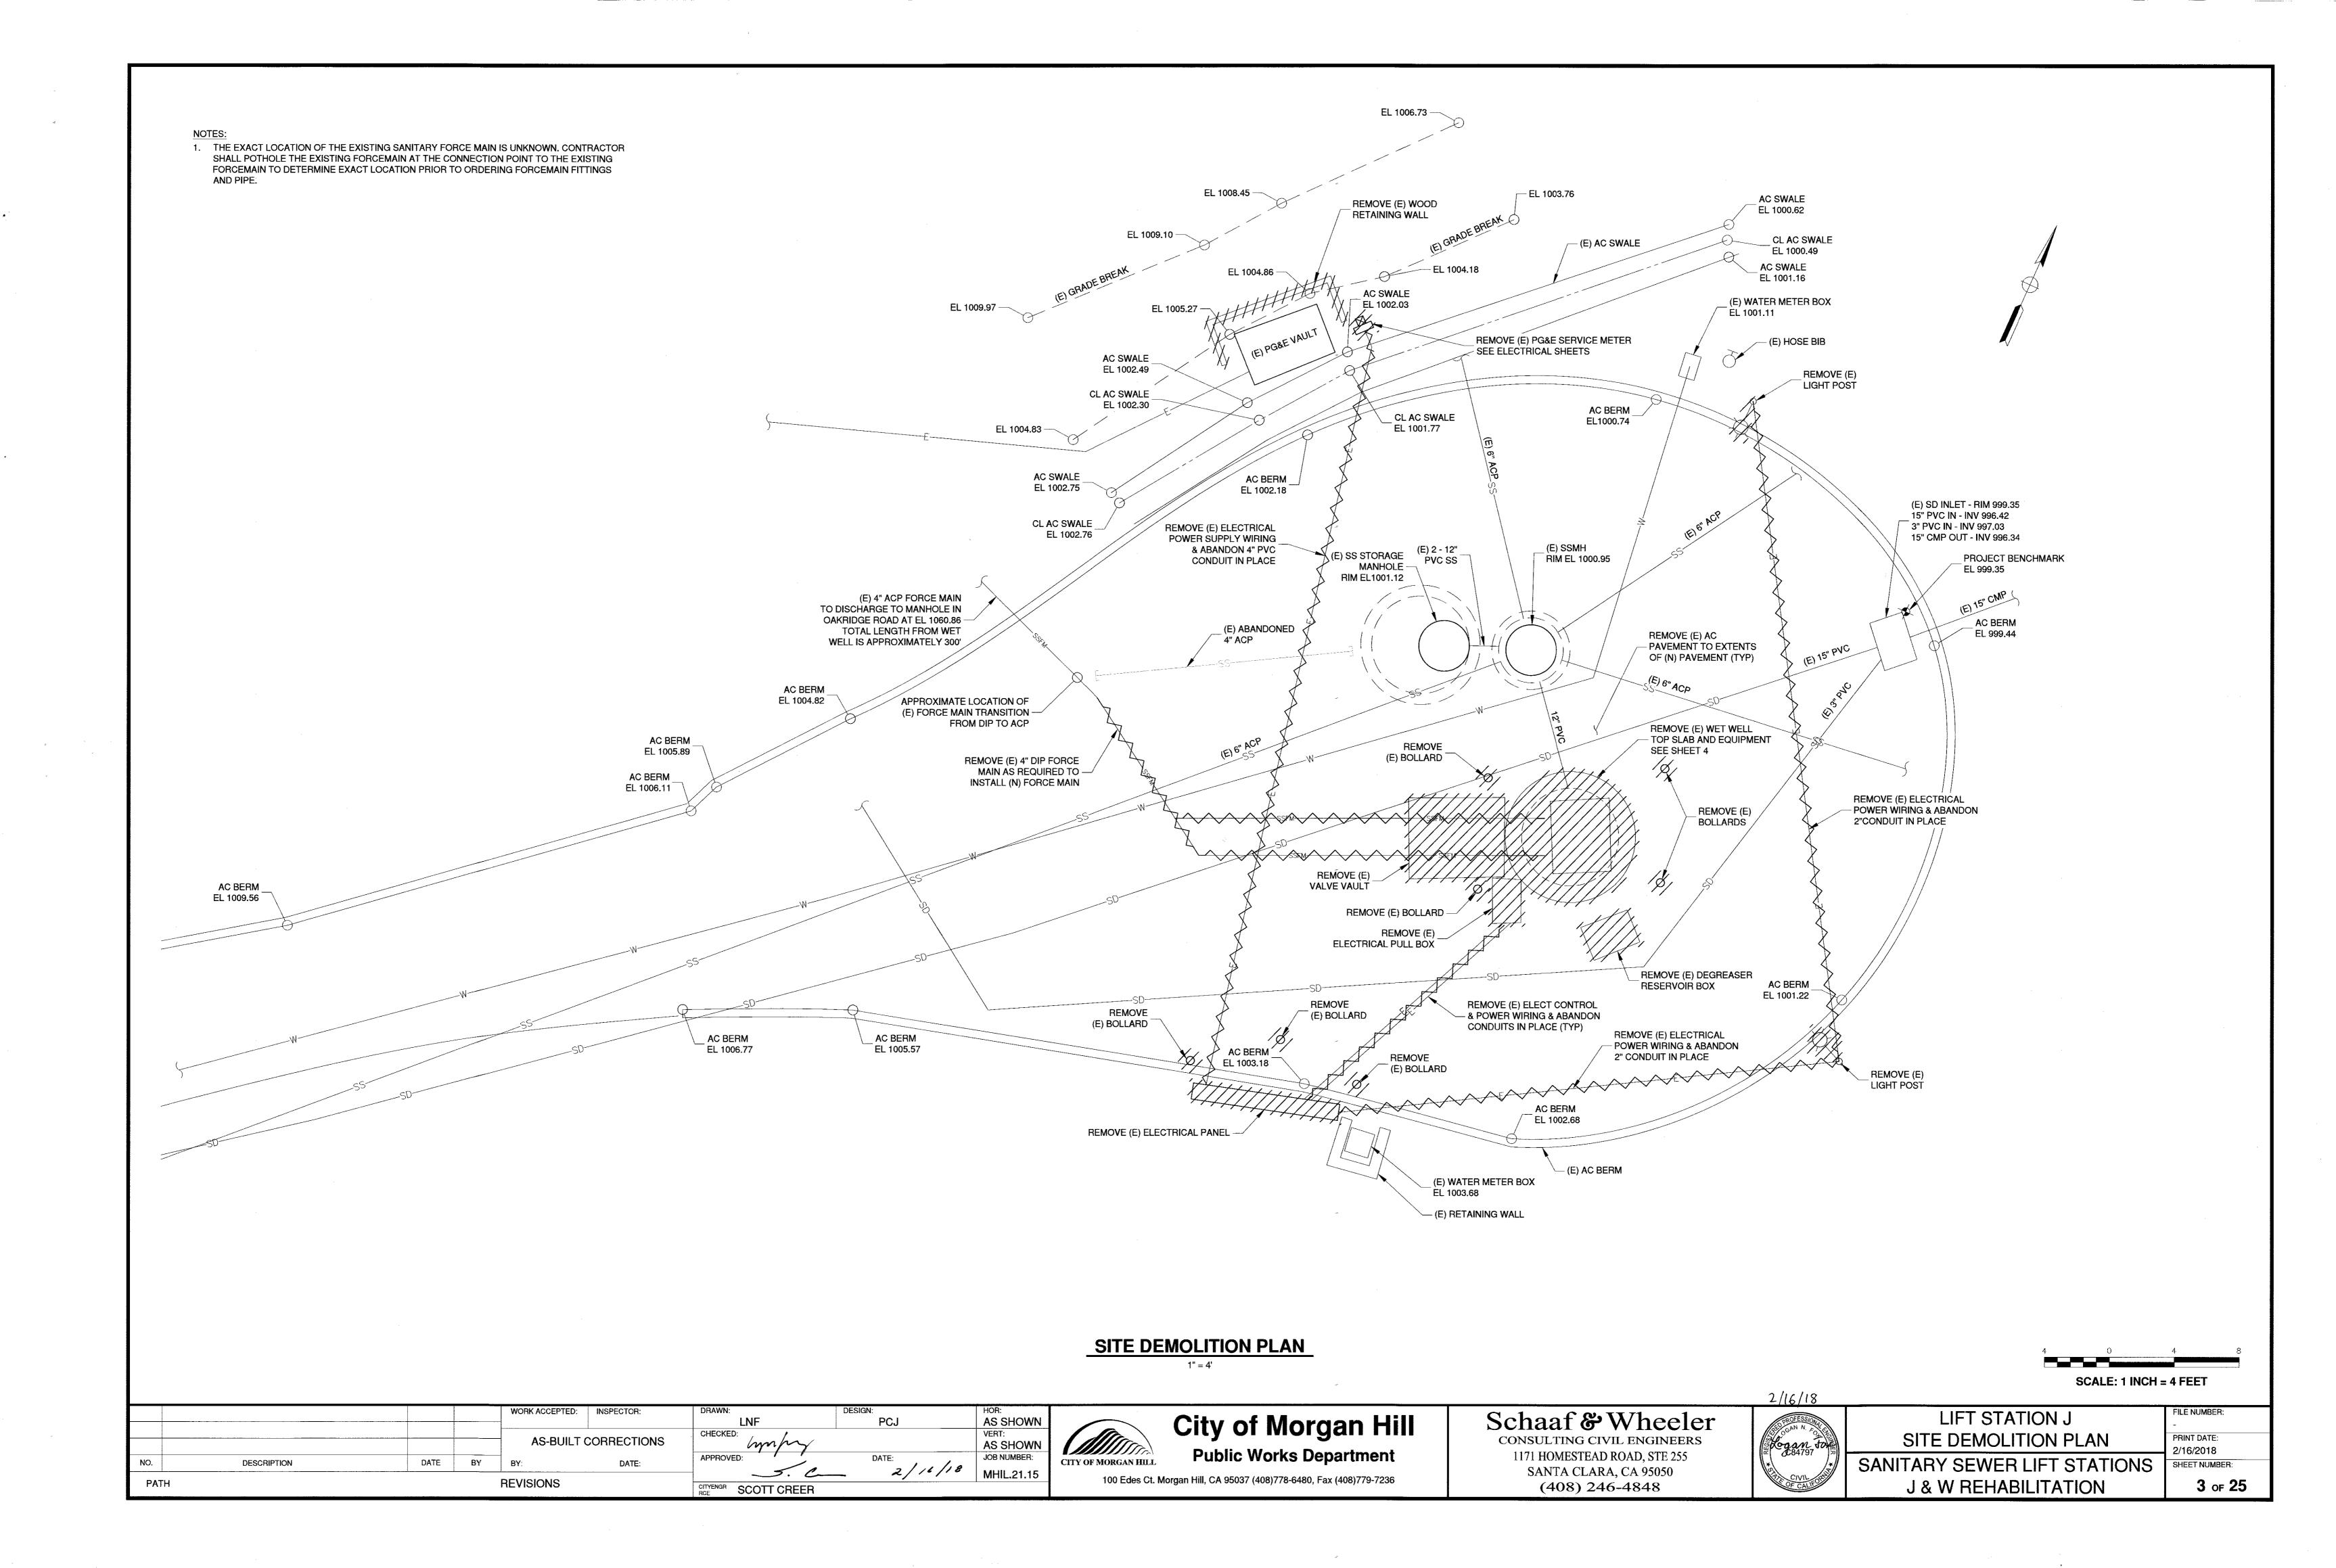

PUMP STATION DEMOLITION SECTION

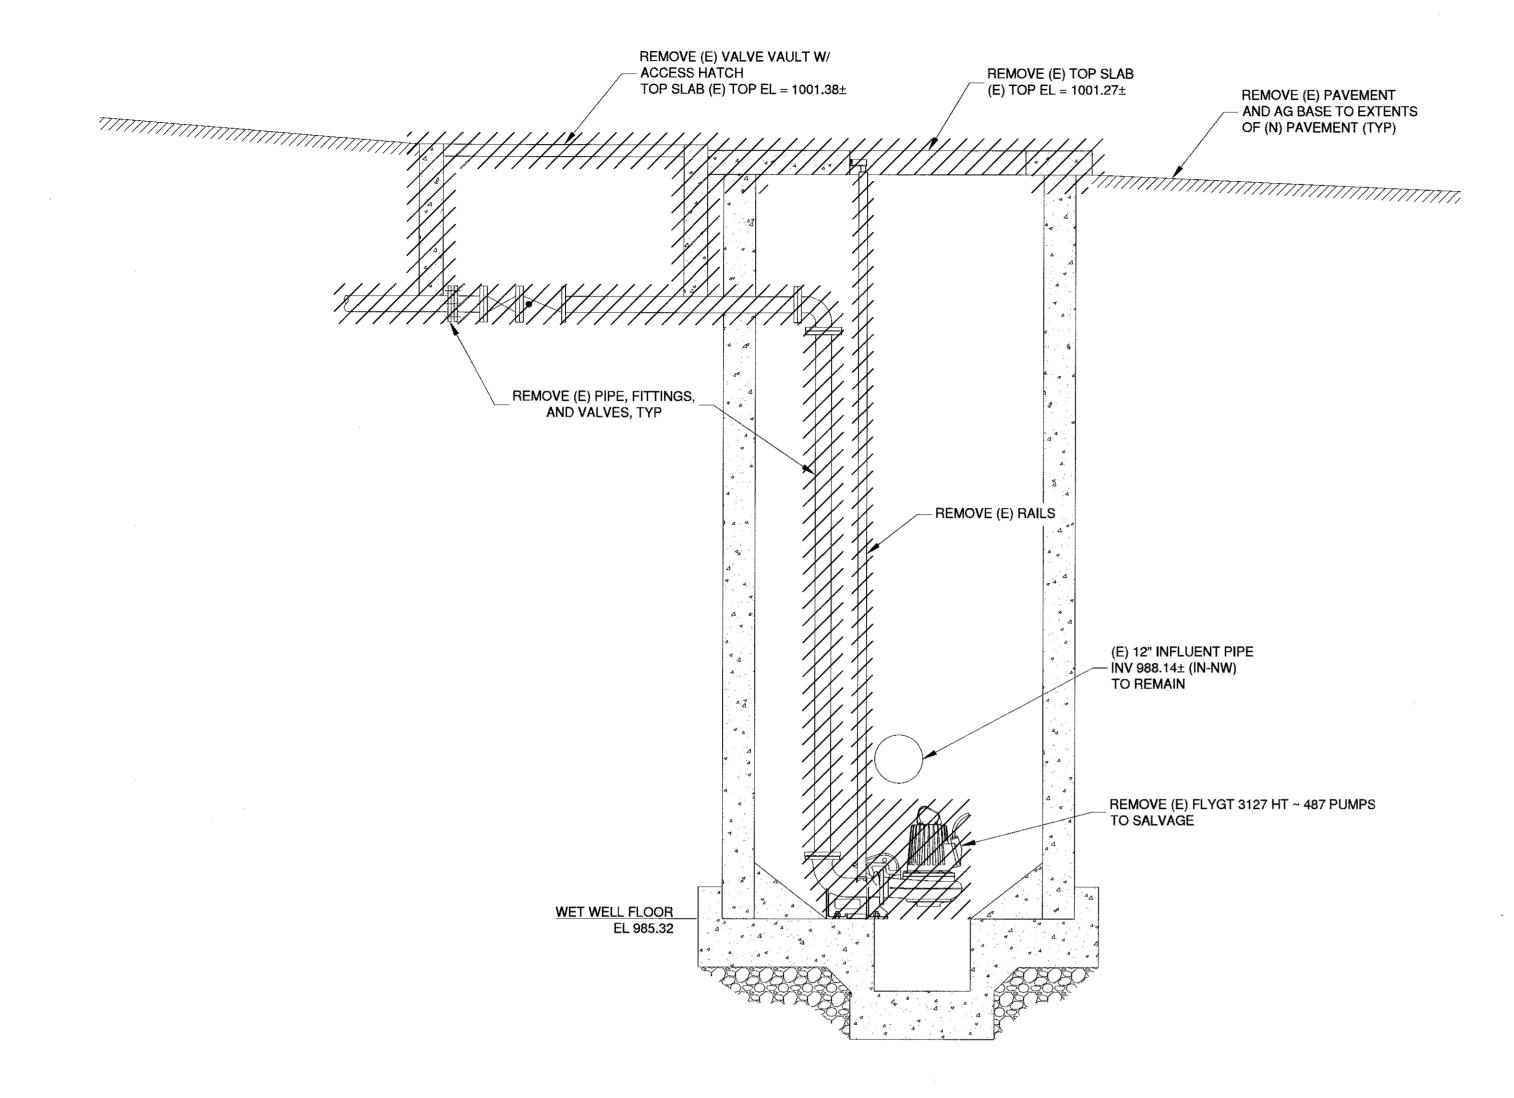1/2" = 1'-0"

				,				
				WORK ACCEPTED:	INSPECTOR:	DRAWN:	DESIGN:	HOR:
						LNF	PCJ	AS SHOWN
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City of Morgan Hill Public Works Department

100 Edes Ct. Morgan Hill, CA 95037 (408)778-6480, Fax (408)779-7236

DEMOLITION NOTES:

1. CONTRACTOR SHALL TAKE CARE NOT TO DAMAGE PORTIONS OF

STRUCTURES SHALL BE CUT AND GROUND FLUSH WITH THE

EXISTING EQUIPMENT TO BE SALVAGED. CONTRACTOR SHALL TRANSPORT ANY SALVAGED EQUIPMENT TO CITY MAINTENANCE

2. REMOVE EXISTING CONTROL EQUIPMENT FROM WET WELL.

3. EXISTING METAL ANCHORED TO THE EXISTING CONCRETE

4. CITY SHALL HAVE THE RIGHT OF FIRST REFUSAL FOR PUMPS,

YARD LOCATED AT100 EDIES COURT, MORGAN HILL.

ANY OTHER FACILITIES TO REMAIN.

CONCRETE SURFACE.

THE EXISTING CONCRETE WET WELL STRUCTURE TO REMAIN OR

ACCESSORIES, AND ALL OTHER EQUIPMENT TO BE REMOVED UNDER THE WORK OF THIS PROJECT. CARE SHALL BE TAKEN NOT TO DAMAGE


CONSULTING CIVIL ENGINEERS
1171 HOMESTEAD ROAD, STE 255
SANTA CLARA, CA 95050
(408) 246-4848


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LIFT STATION J DEMOLITION SECTION SANITARY SEWER LIFT STATIONS J & W REHABILITATION


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4 OF 25


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LIFT STATION IMPROVEMENT PLAN




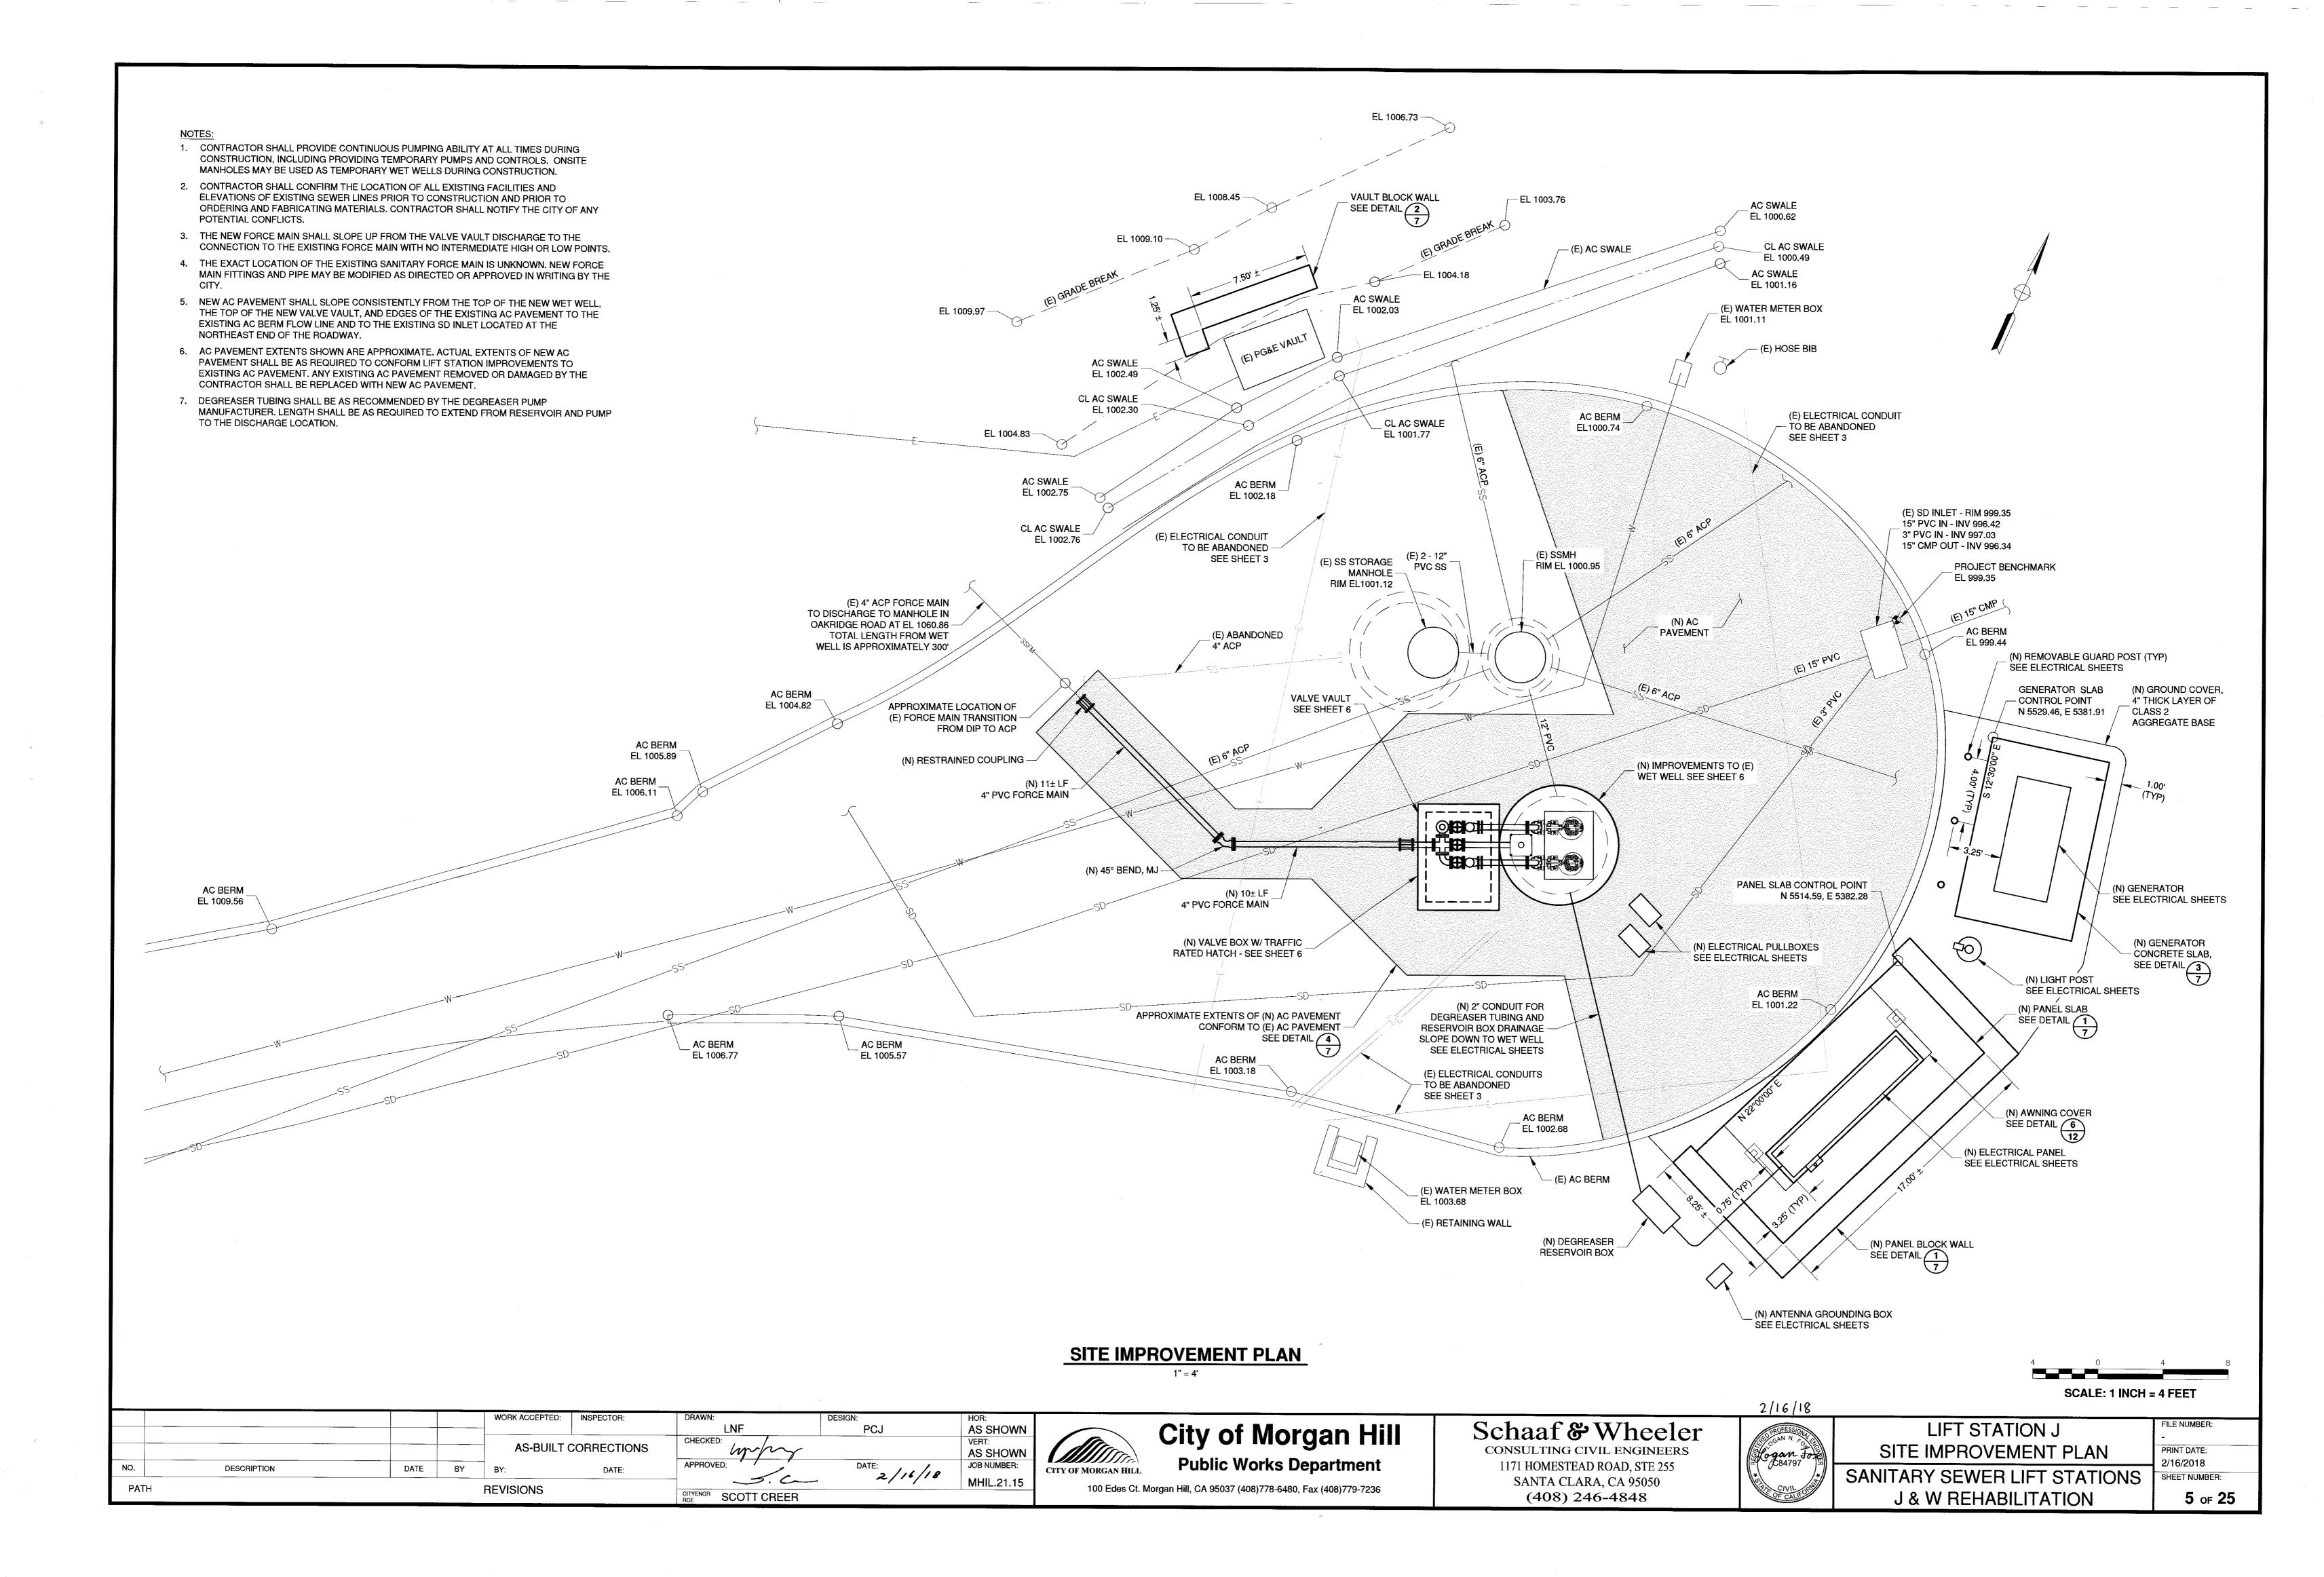

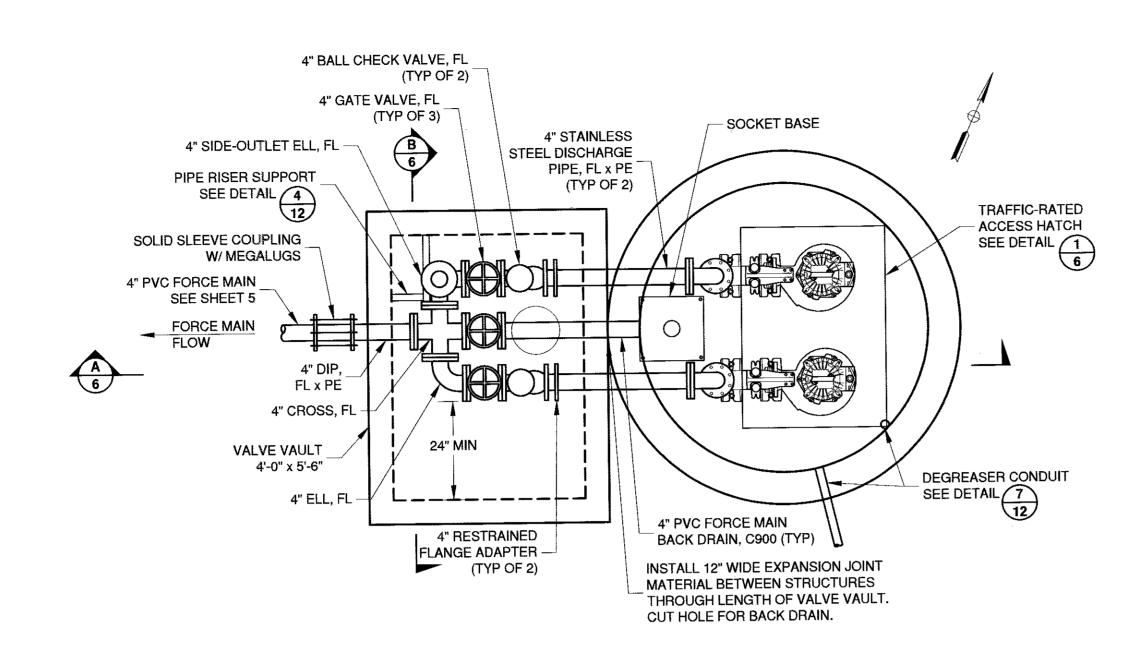1. DIMENSIONS SHOWN ARE CLEAR OPENINGS.

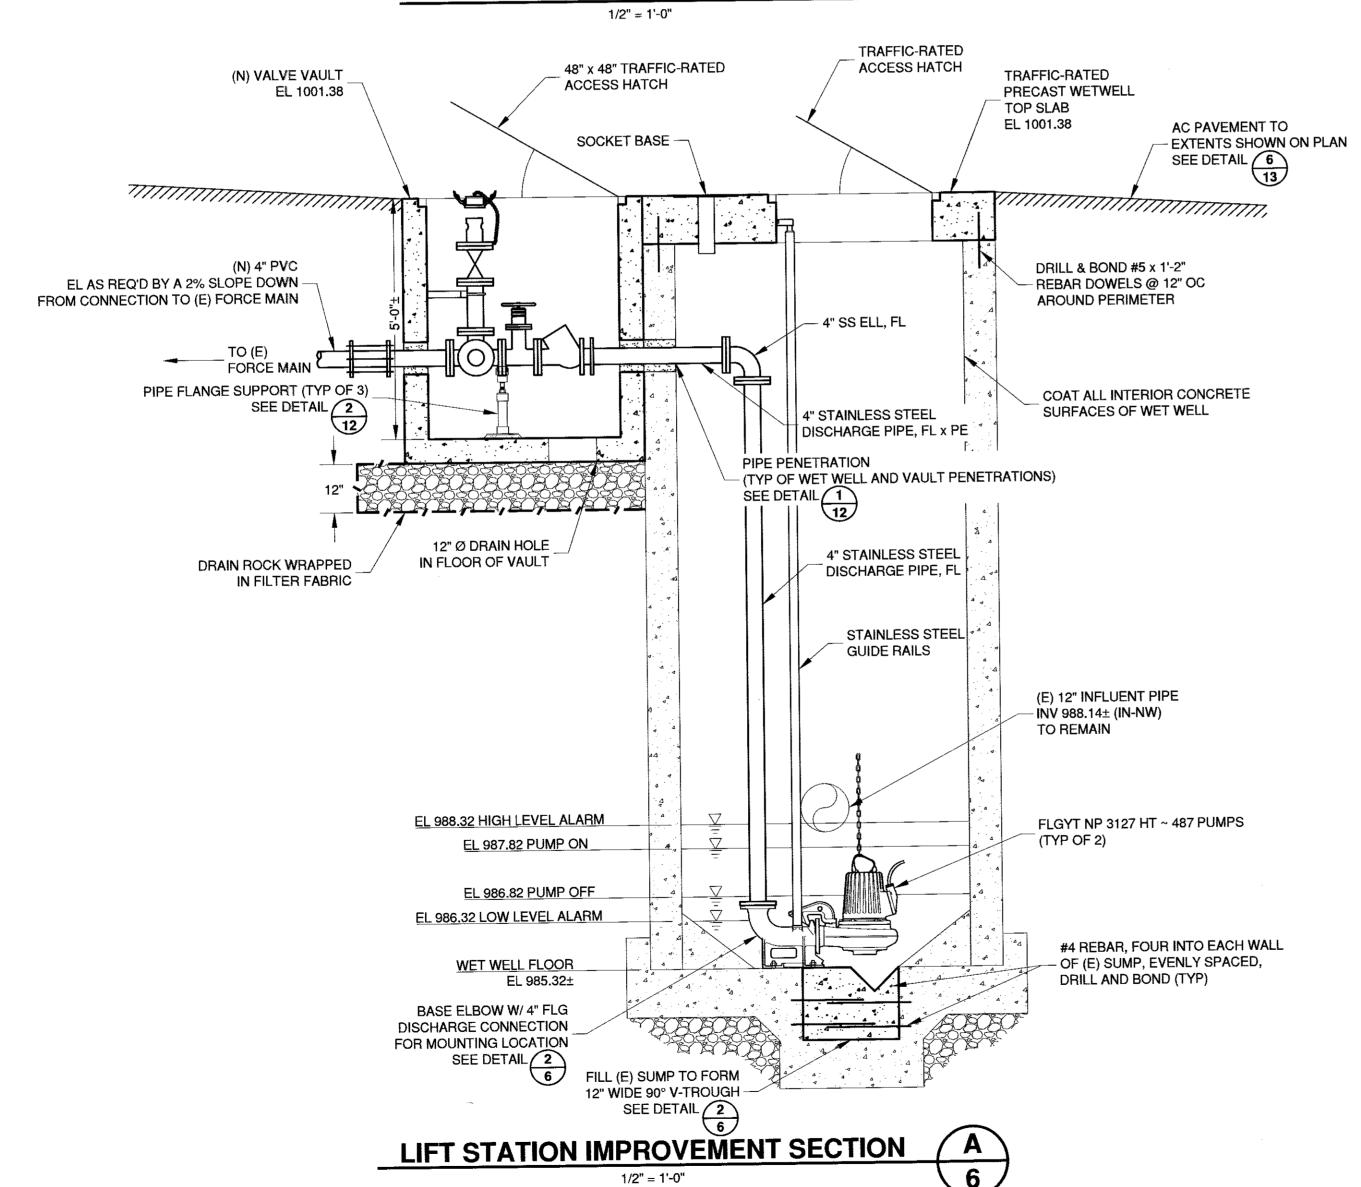
- 2. HATCH SHALL BE AN ALUMINUM TRAFFIC-RATED HATCH WITH FALL PROTECTION AND A SPRING-ASSIST LIFT MECHANISM.
- PROTECTION AND A SPRING-ASSIST LIFT MECHANISM.
- 3. ALL ACCESS HATCHES SHALL BE MANUFACTURED BY SYRACUSE CASTINGS OR APPROVED EQUAL.

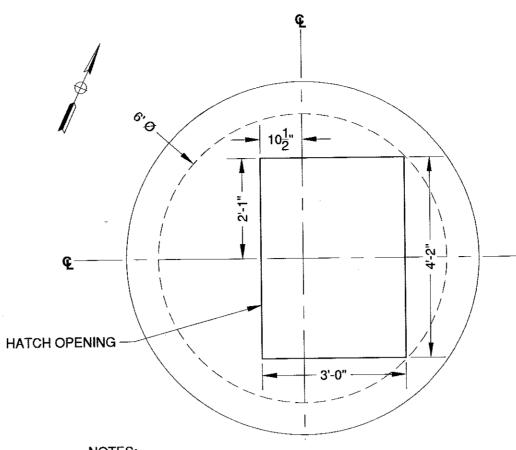

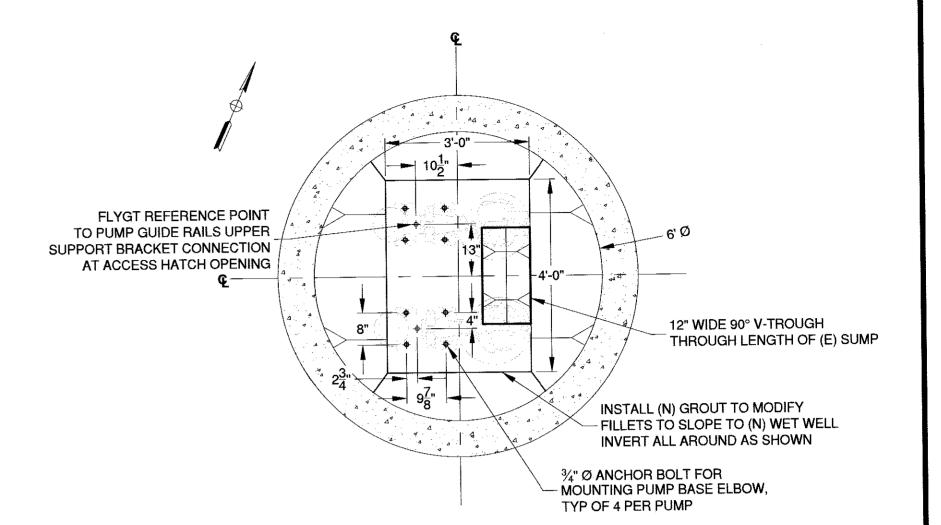

PUMP MOUNTING DETAIL 2

1/2" = 1'-0" 6

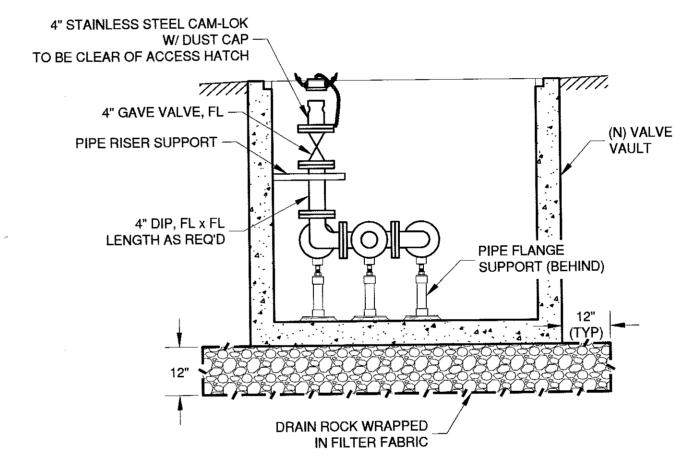

VALVE VAULT SECTION B

1/2" = 1'-0"

6

NOTES:

- 1. PUMP CONTROL LEVELS SHOWN ARE BASED ON AN APPROXIMATE WET WELL FLOOR ELEVATION. ACTUAL PUMP CONTROL LEVELS SHALL BE ADJUSTED BASED ON ACTUAL WET WELL FLOOR ELEVATION.
- 2. ALL MJ FITTINGS AND UNRESTRAINED JOINTS SHALL BE RESTRAINED WITH EBAA MEGALUGS OR APPROVED EQUIVALENT.
- 3. ALL BURIED DUCTILE IRON PIPE AND FITTINGS SHALL BE WRAPPED WITH A POLYETHYLENE ENCASEMENT PER AWWA STANDARD C105.
- 4. ALL HARDWARE SHALL BE TYPE 316 STAINLESS STEEL UNLESS OTHERWISE SPECIFIED. ALL NEW DUCTILE IRON PIPE, FITTINGS, AND VALVES SHALL BE EPOXY LINED AND COATED.
- 5. ALL GATE VALVES SHALL HAVE HAND WHEELS.
- 6. ALL INTERIOR SURFACES OF CONCRETE WET WELL STRUCTURE SHALL BE COATED WITH A TWO-PART SYSTEM CONSISTING OF AN EPOXY BASE COAT AND A HIGH BUILD POLYURETHANE ELASTOMER TOP COAT PER SPECIFICATION. COATING SHALL BE APPLIED AFTER THE WET WELL STRUCTURE IMPROVEMENTS ARE COMPLETE AND PRIOR TO THE INSTALLATION OF NEW EQUIPMENT.
- 7. ALL SURFACES TO BE COATED SHALL BE THOROUGHLY CLEANED AND PREPARED ACCORDING TO THE SPECIFICATIONS PRIOR TO COATING.
- 8. SOCKET BASE FOR PORTABLE DAVIT CRANE SHALL BE A THERN MODEL 510F. BASE SHALL
- BE STAINLESS STEEL AND MOUNTED FLUSH WITH THE TOP OF CONCRETE.
- 9. EXPANSION JOINT MATERIAL INSTALLED BETWEEN STRUCTURES SHALL BE "FIBRE EXPANSION JOINT" BY W.R. MEADOWS OR APPROVED EQUAL.

	·			WORK ACCEPTED:	INSPECTOR:	DRAWN:	DESIGN: PCJ	HOR: AS SHOWN	
				AS-BUILT	CORRECTIONS	APPROVED:	DATE:	VERT: AS SHOWN JOB NUMBER:	1
NO.	DESCRIPTION	DATE	BY	BY:	DATE:	AFFROVED	2/16/18	MHIL.21.15	,
PATH				REVISIONS		CITYENGR SCOTT CREER			



City of Morgan Hill Public Works Department

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LIFT STATION J IMPROVEMENT PLAN & SECTIONS


SANITARY SEWER LIFT STATIONS
J & W REHABILITATION

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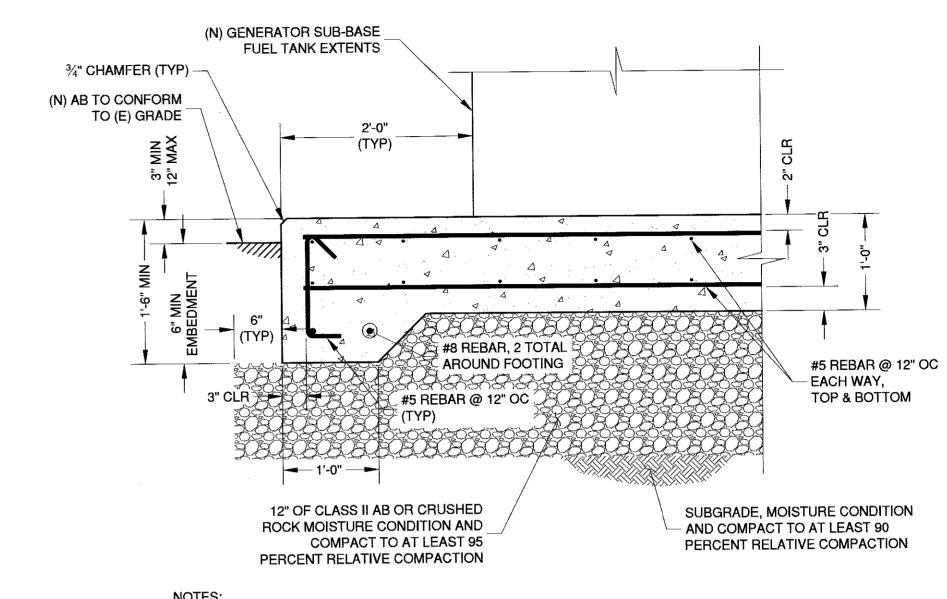


PANEL SLAB AND BLOCK WALL DETAIL

NOTES:

1. REPLACE ANY DAMAGED AC BERM OR PAVEMENT.

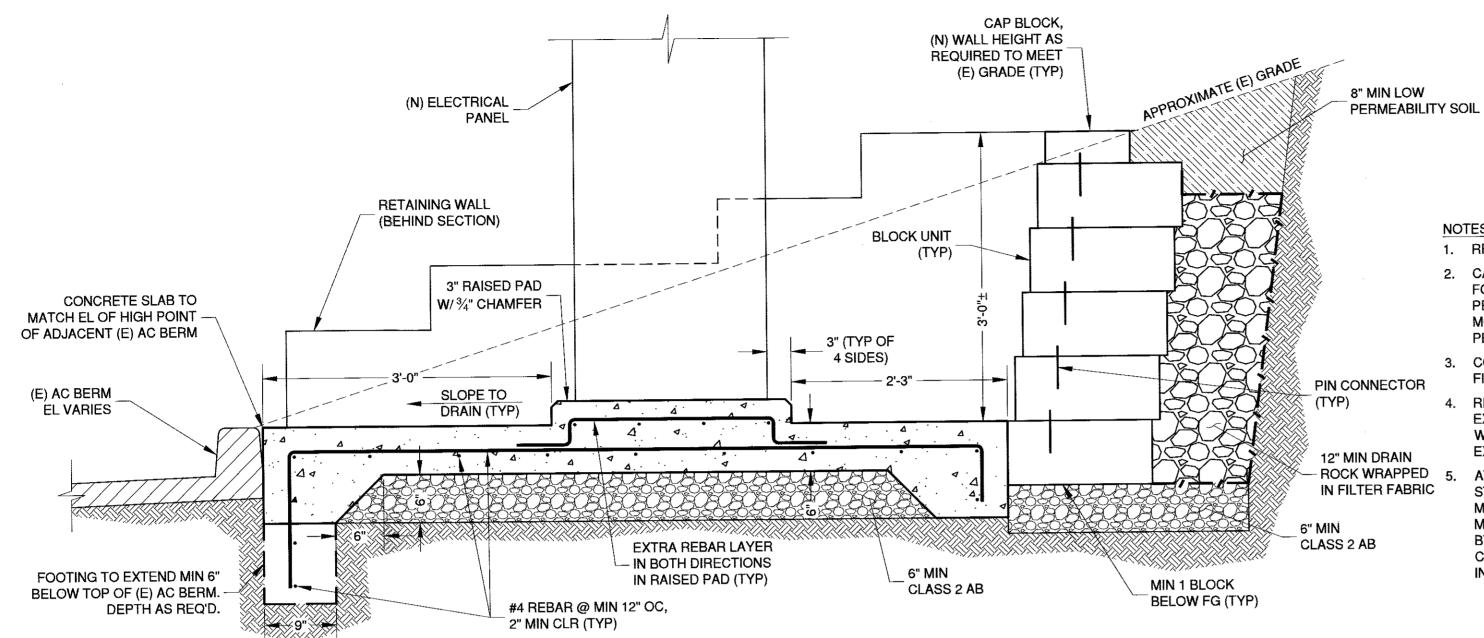
- 2. CALTRANS CLASS 2 AGGREGATE BASE FOR CONCRETE FOUNDATION AND WALL SHALL BE COMPACTED TO A MINIMUM OF 95 PERCENT RELATIVE COMPACTION. SOIL SUBGRADE SHALL BE MOISTURE CONDITIONED AND COMPACTED TO AT LEAST 90 PERCENT RELATIVE COMPACTION.
- 3. CONCRETE SLAB FOOTING SHALL EXTEND A MINIMUM OF 6" BELOW FINISH GRADE OR EXISTING GRADE; WHICHEVER IS DEEPER.
- 4. RETAINING WALLS TO THE SÎDES OF NEW ELECTRICAL PANEL SHALL EXTEND TO APPROXIMATELY 6 INCHES HORIZONTALLY BEYOND WHERE THE GRADE OF THE NEW CONCRETE SLAB MATCHES THE EXISTING GRADE.
- AT CAST-IN-PLACE CONCRETE SLAB INTERFACE WITH CONCRETE STRUCTURES (INCLUDING CONCRETE BOXES), AN EXPANSION JOINT MATERIAL AND SEALANT SHALL BE USED. EXPANSION JOINT MATERIAL SHALL BE "FIBRE EXPANSION JOINT" AS MANUFACTURED BY W.R. MEADOWS OR APPROVED EQUAL. INSTALLATION SHALL CONFORM WITH THE MANUFACTURERS INSTALLATION INSTRUCTIONS.




SLOPE SLAB TO DRAIN OFF EDGES OF SLAB.

GENERATOR CONCRETE SLAB DETAIL 3

N.T.S. 7

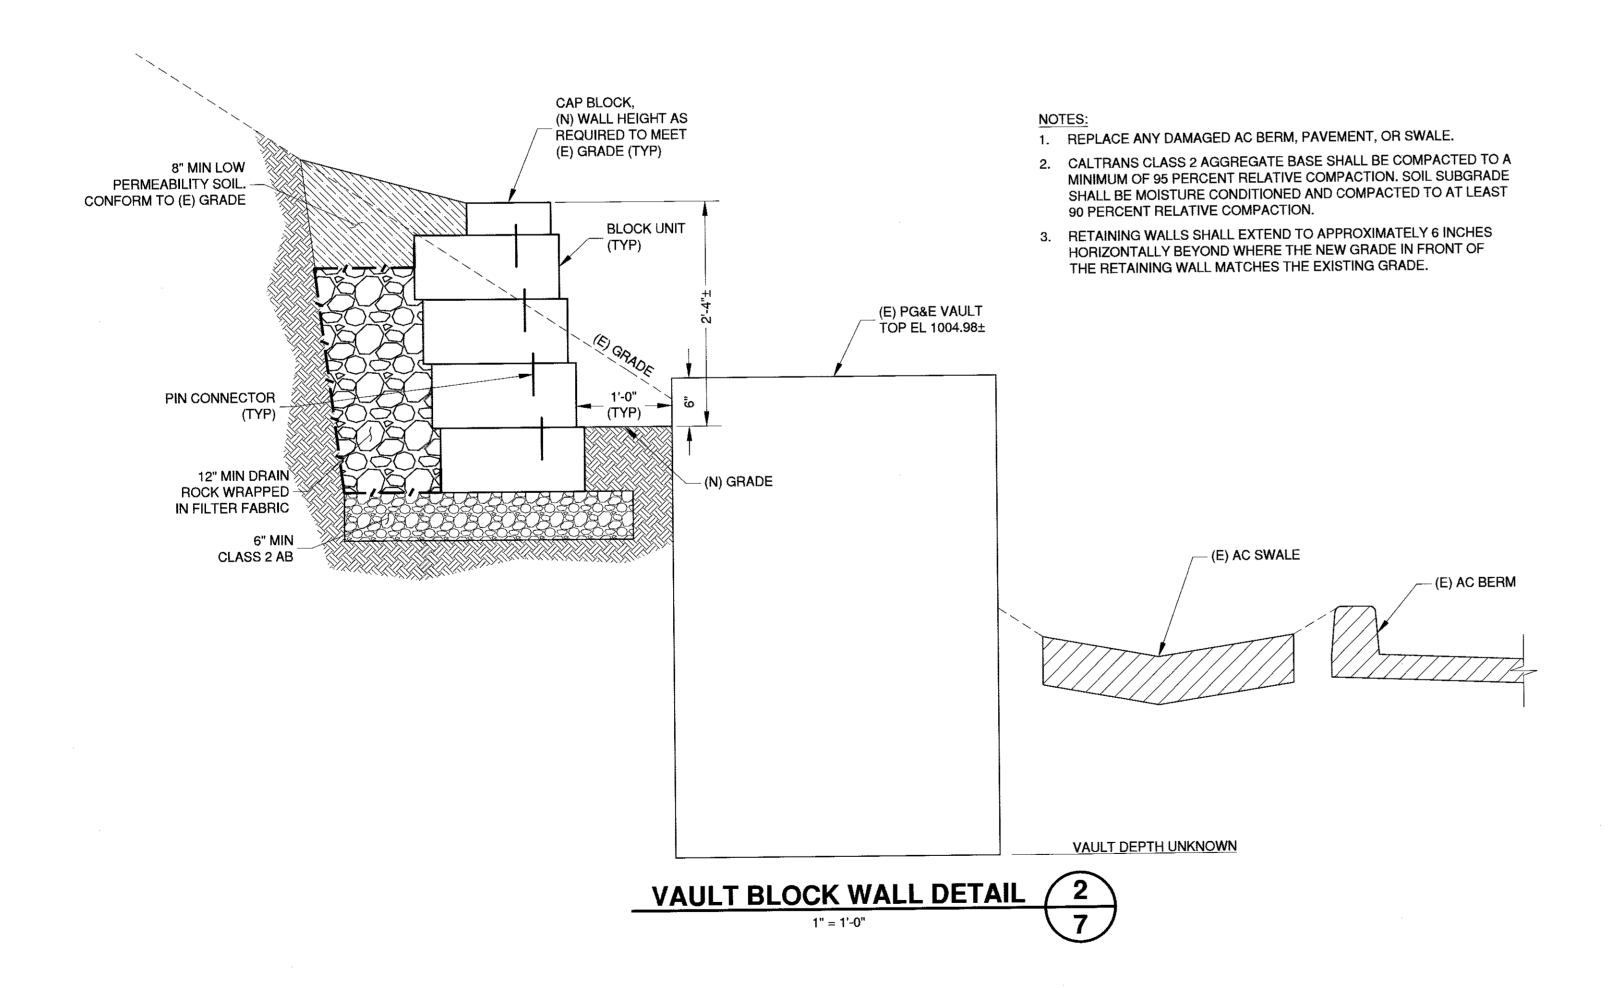

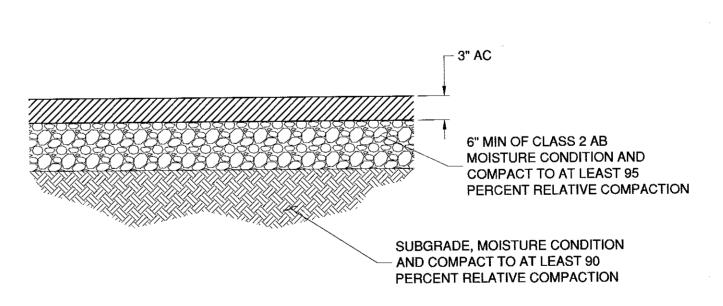

NOTE: EXISTING PAVEMENT WHICH IS TO BE JOINED BY NEW PAVEMENT SHALL BE SAW CUT VERTICALLY TO PROVIDE STRAIGHT, TRUE, AND NEAT JOINTS. THE VERTICAL EDGES SHALL BE TACKED PRIOR TO PAVING.

AC PAVEMENT DETAIL 4

N.T.S. 7

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PATH				REVISIONS	CITYENGR SCOTT CREER		



City of Morgan Hill
Public Works Department

100 Edes Ct. Morgan Hill, CA 95037 (408)778-6480, Fax (408)779-7236

Schaaf & Wheeler
CONSULTING CIVIL ENGINEERS
1171 HOMESTEAD ROAD, STE 255
SANTA CLARA, CA 95050
(408) 246-4848

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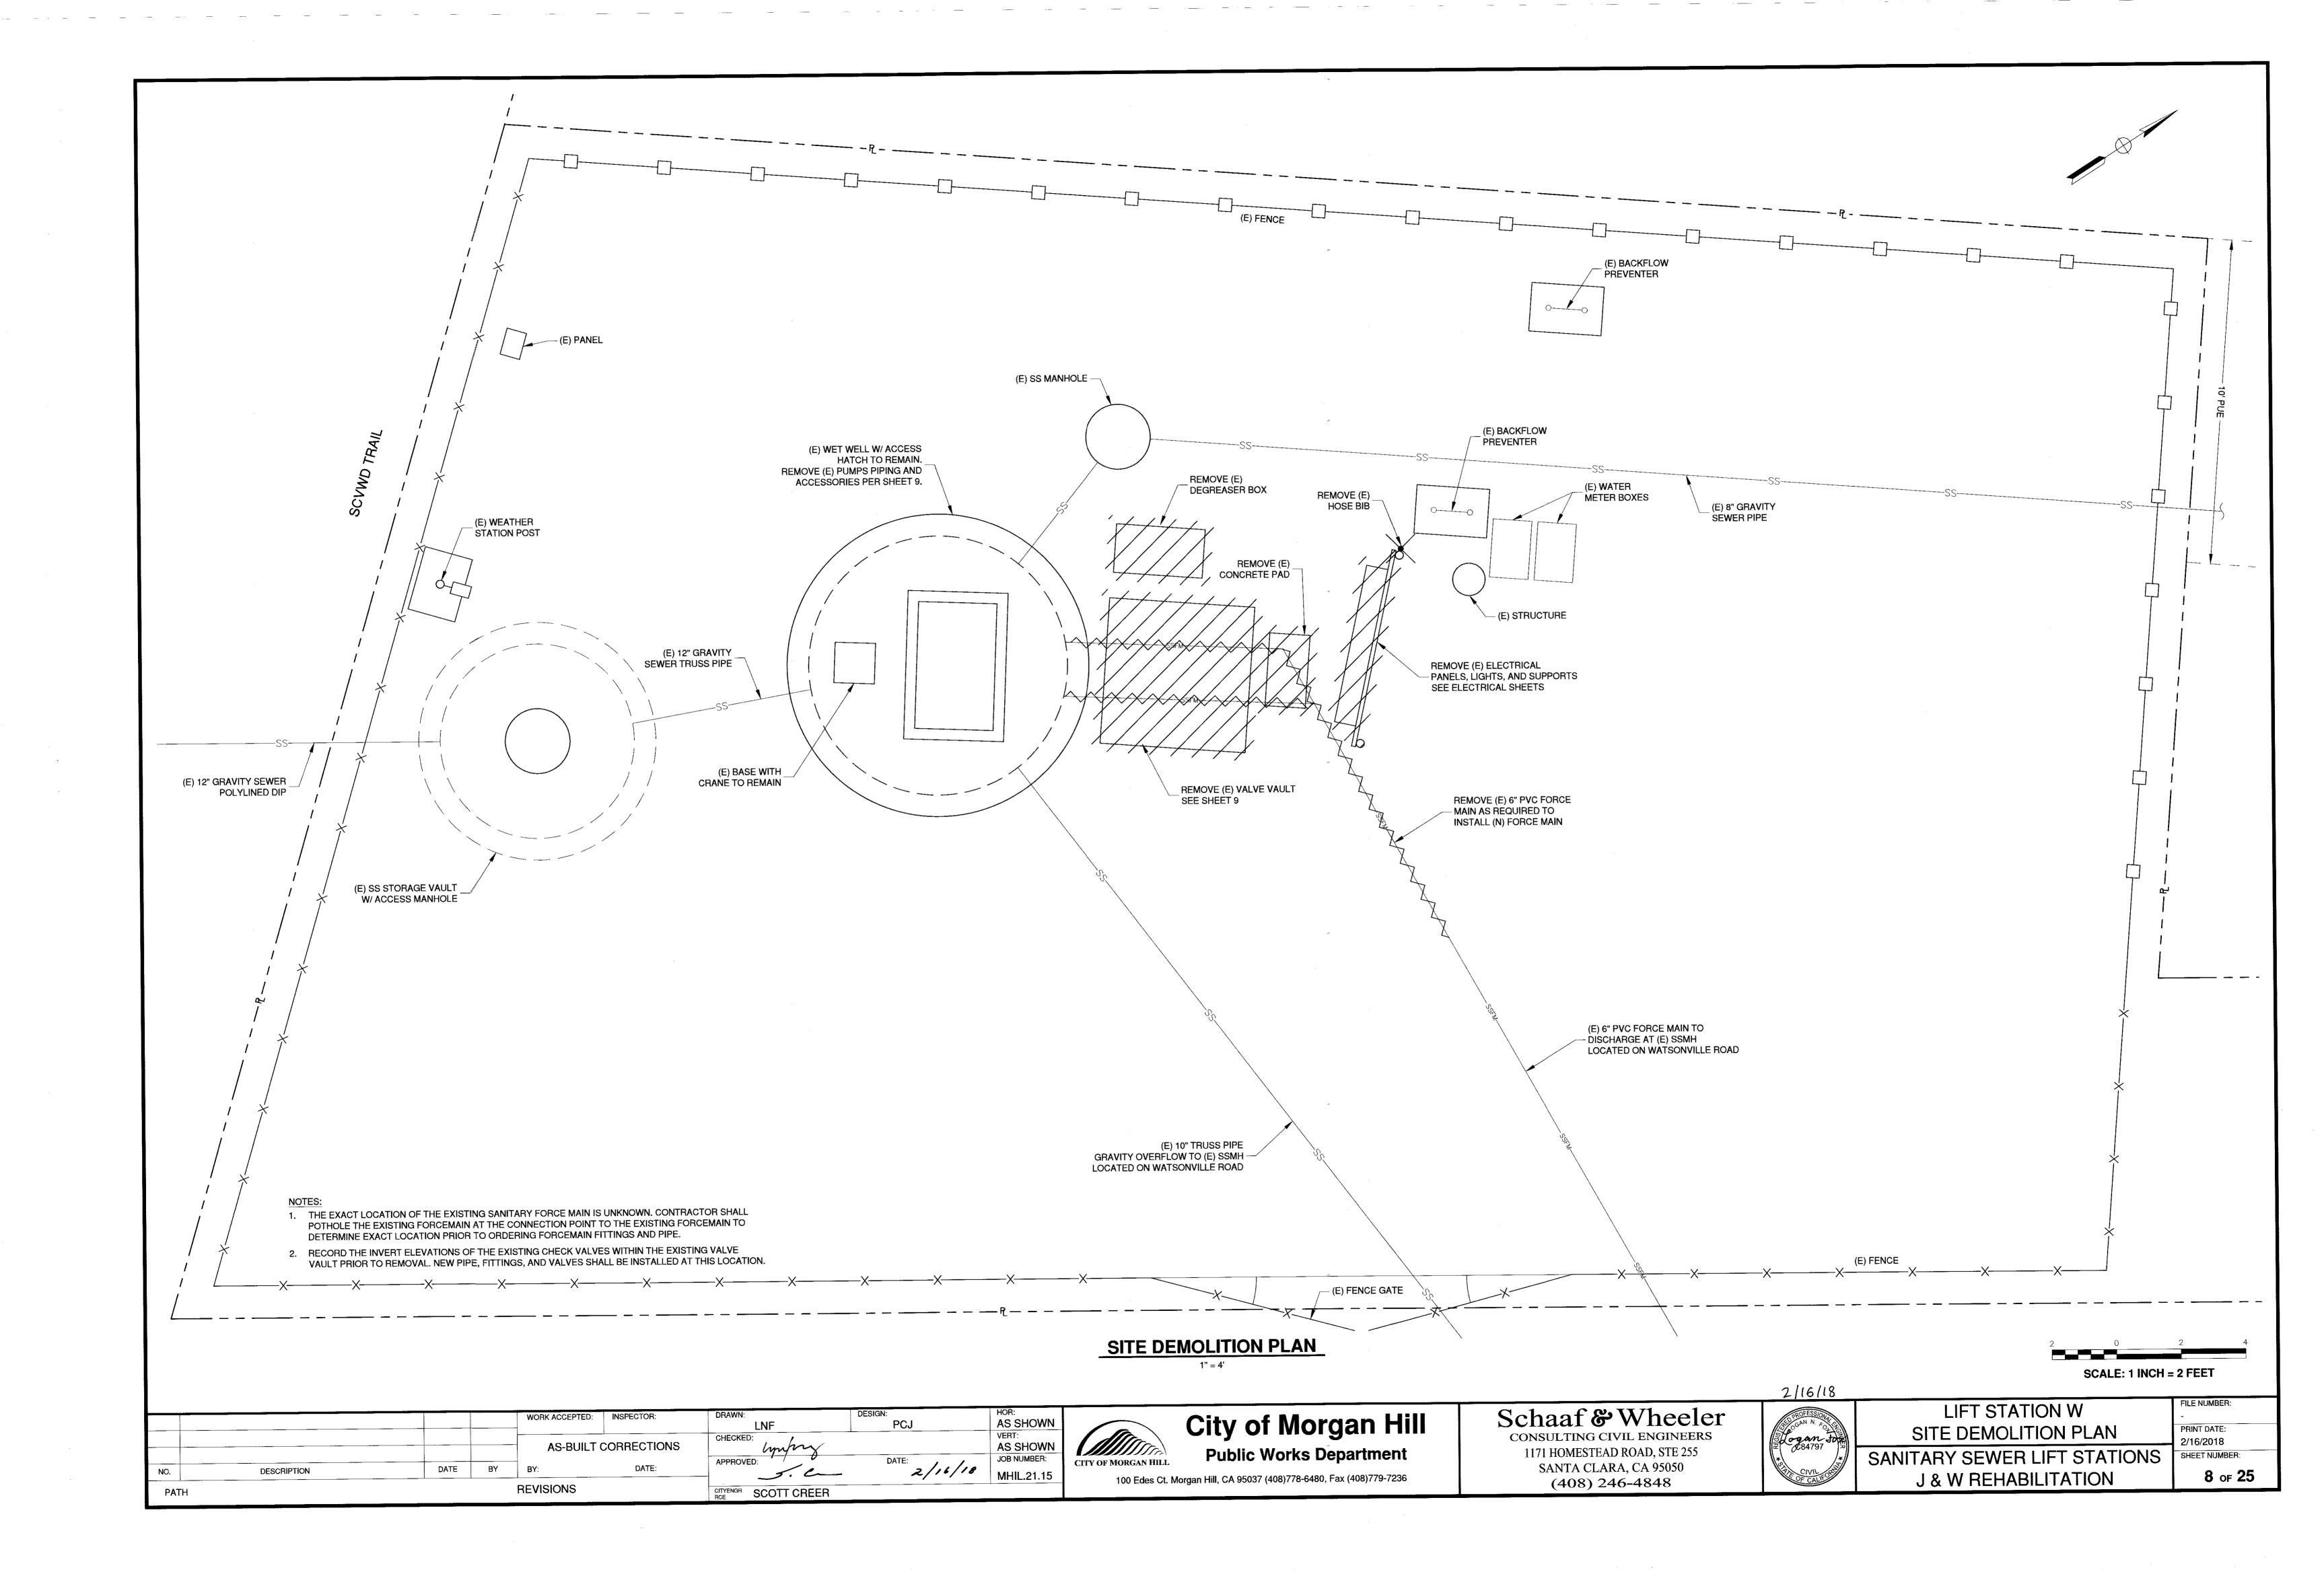
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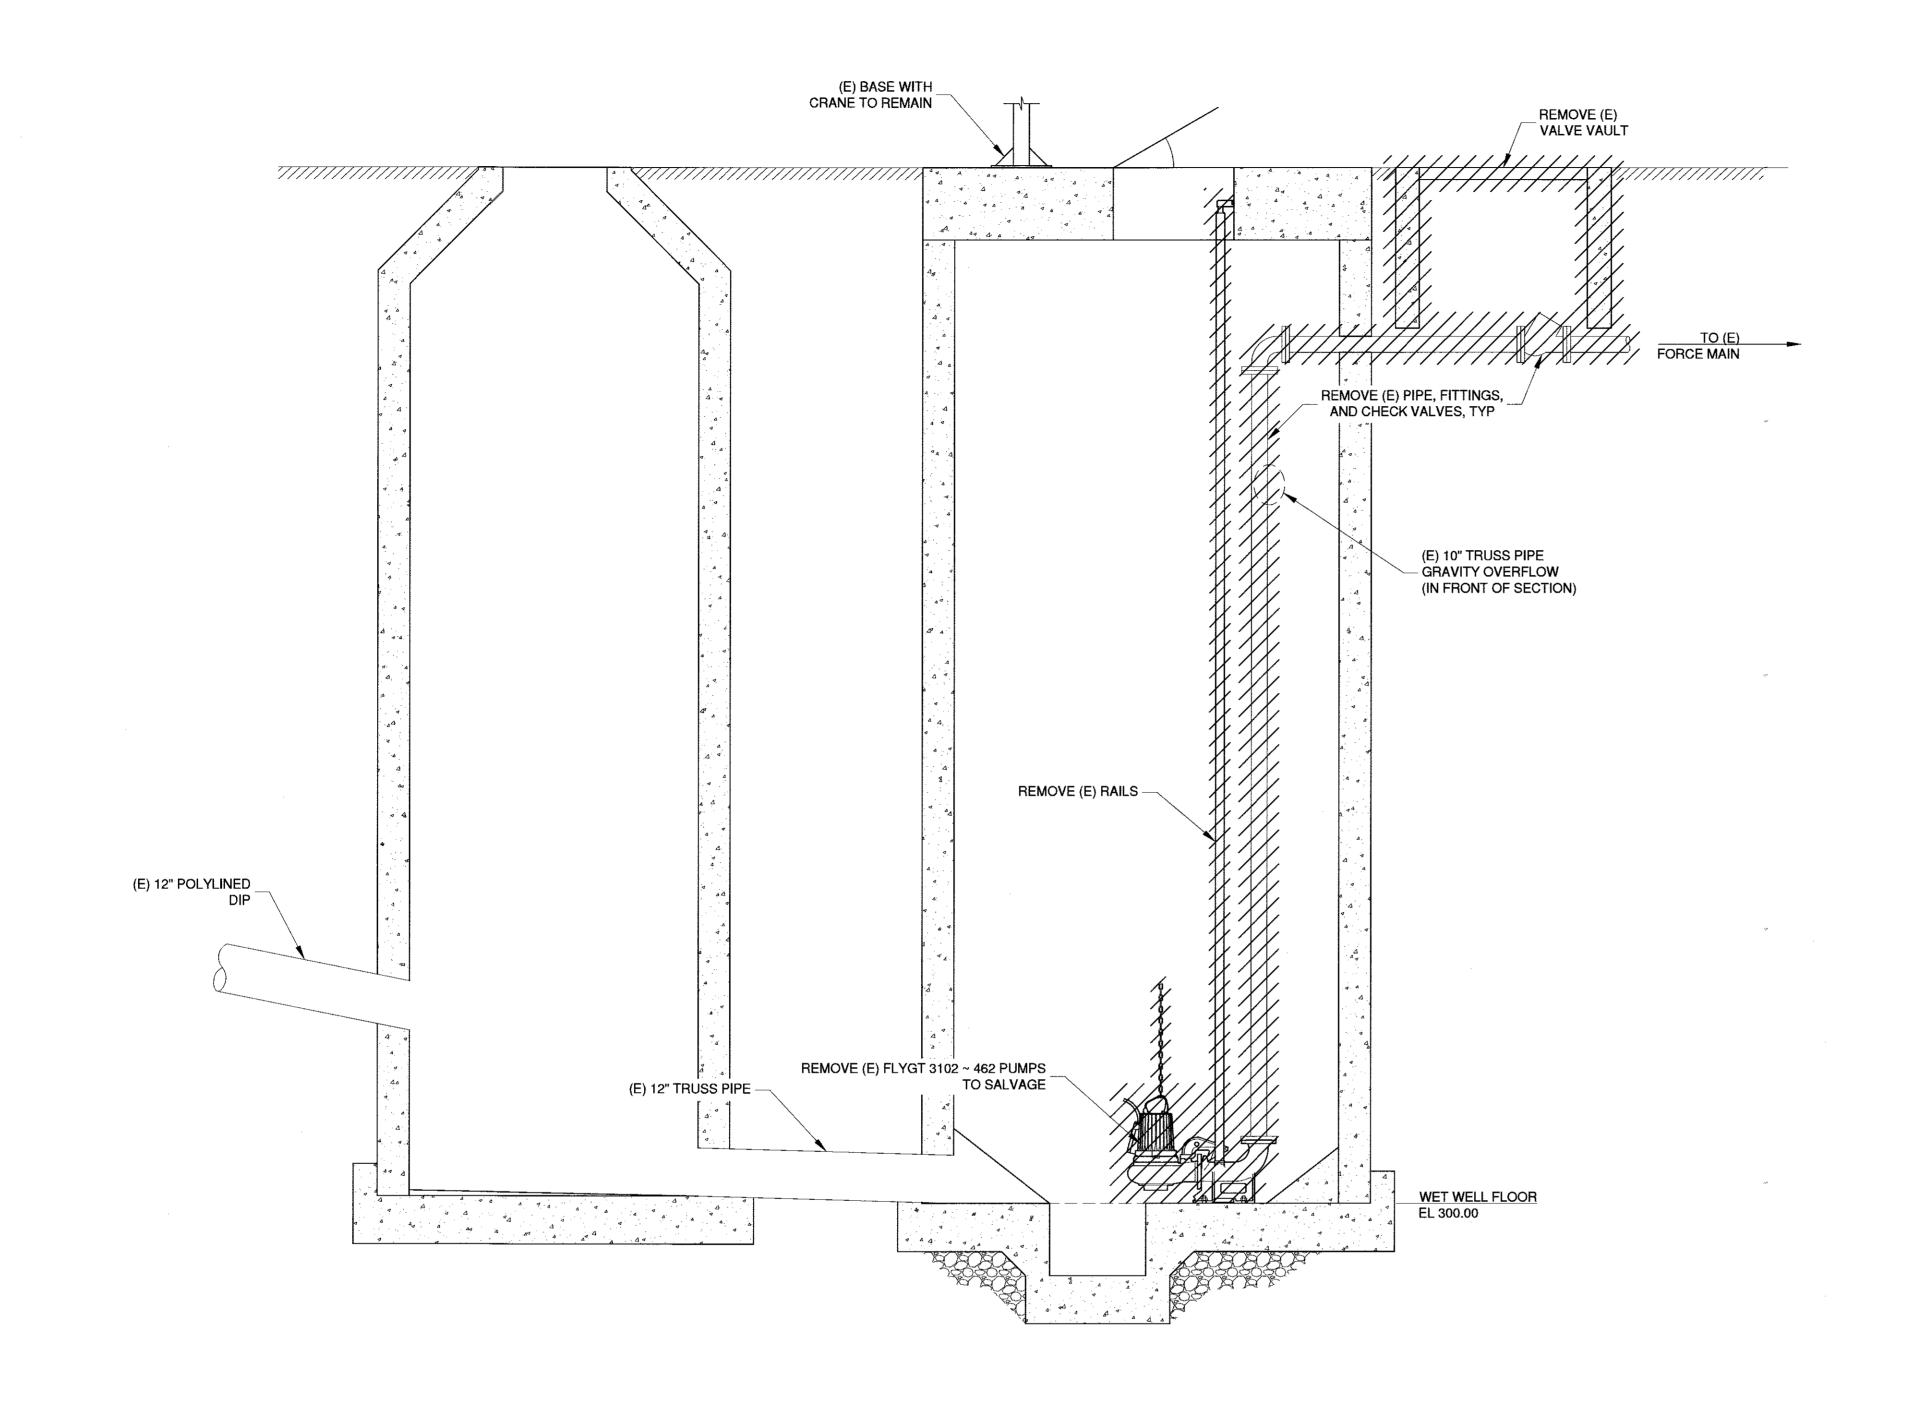
LIFT STATION J
CIVIL DETAILS

SANITARY SEWER LIFT STATIONS
J & W REHABILITATION

2/16/2018
SHEET NUMBER:
7 of 25

PRINT DATE:





DEMOLITION NOTES:

- CONTRACTOR SHALL TAKE CARE NOT TO DAMAGE EXISTING

 FACILITIES TO BEMAIN.
- FACILITIES TO REMAIN.
- 2. REMOVE EXISTING CONTROL EQUIPMENT FROM WET WELL.
- EXISTING METAL ANCHORED TO THE EXISTING CONCRETE STRUCTURES SHALL BE CUT AND GROUND FLUSH WITH THE CONCRETE SURFACE.
- 4. CITY SHALL HAVE THE RIGHT OF FIRST REFUSAL FOR PUMPS, ACCESSORIES, AND ALL OTHER EQUIPMENT TO BE REMOVED UNDER THE WORK OF THIS PROJECT. CARE SHALL BE TAKEN NOT TO DAMAGE EXISTING EQUIPMENT TO BE SALVAGED. CONTRACTOR SHALL TRANSPORT ANY SALVAGED EQUIPMENT TO CITY MAINTENANCE YARD LOCATED AT100 EDIES COURT, MORGAN HILL.

WORK ACCEPTED: INSPECTOR:

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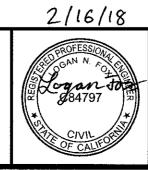


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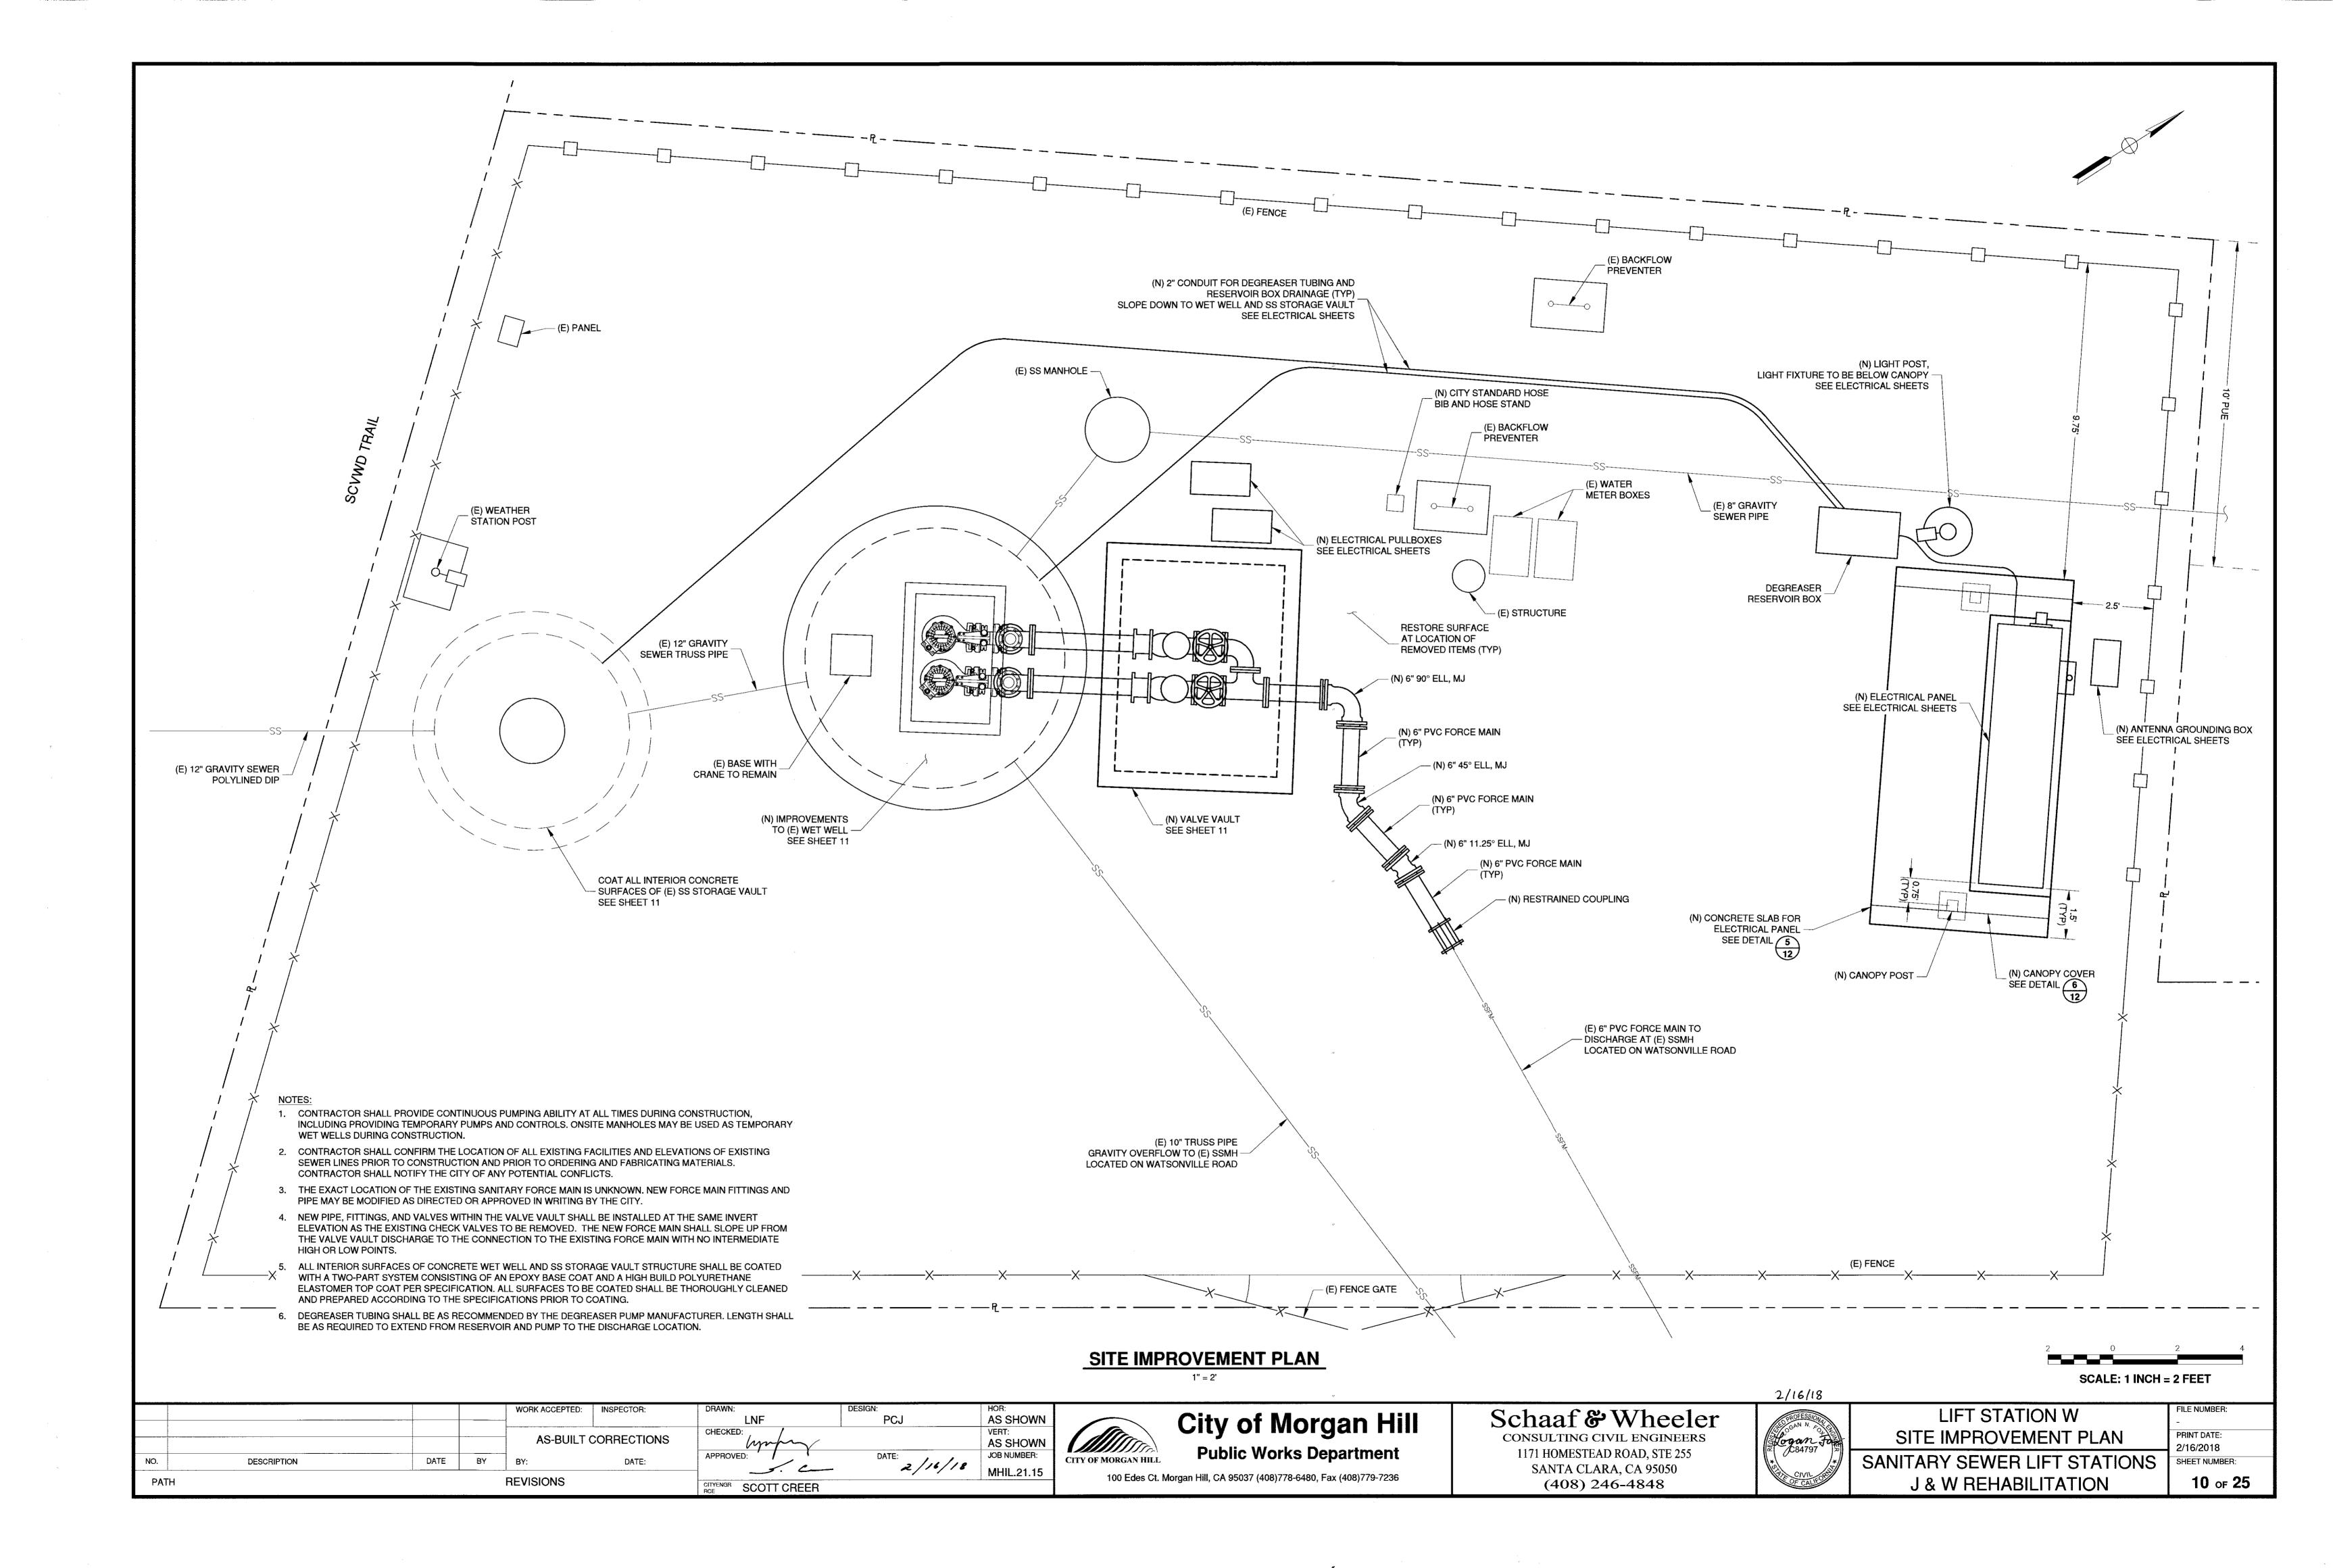
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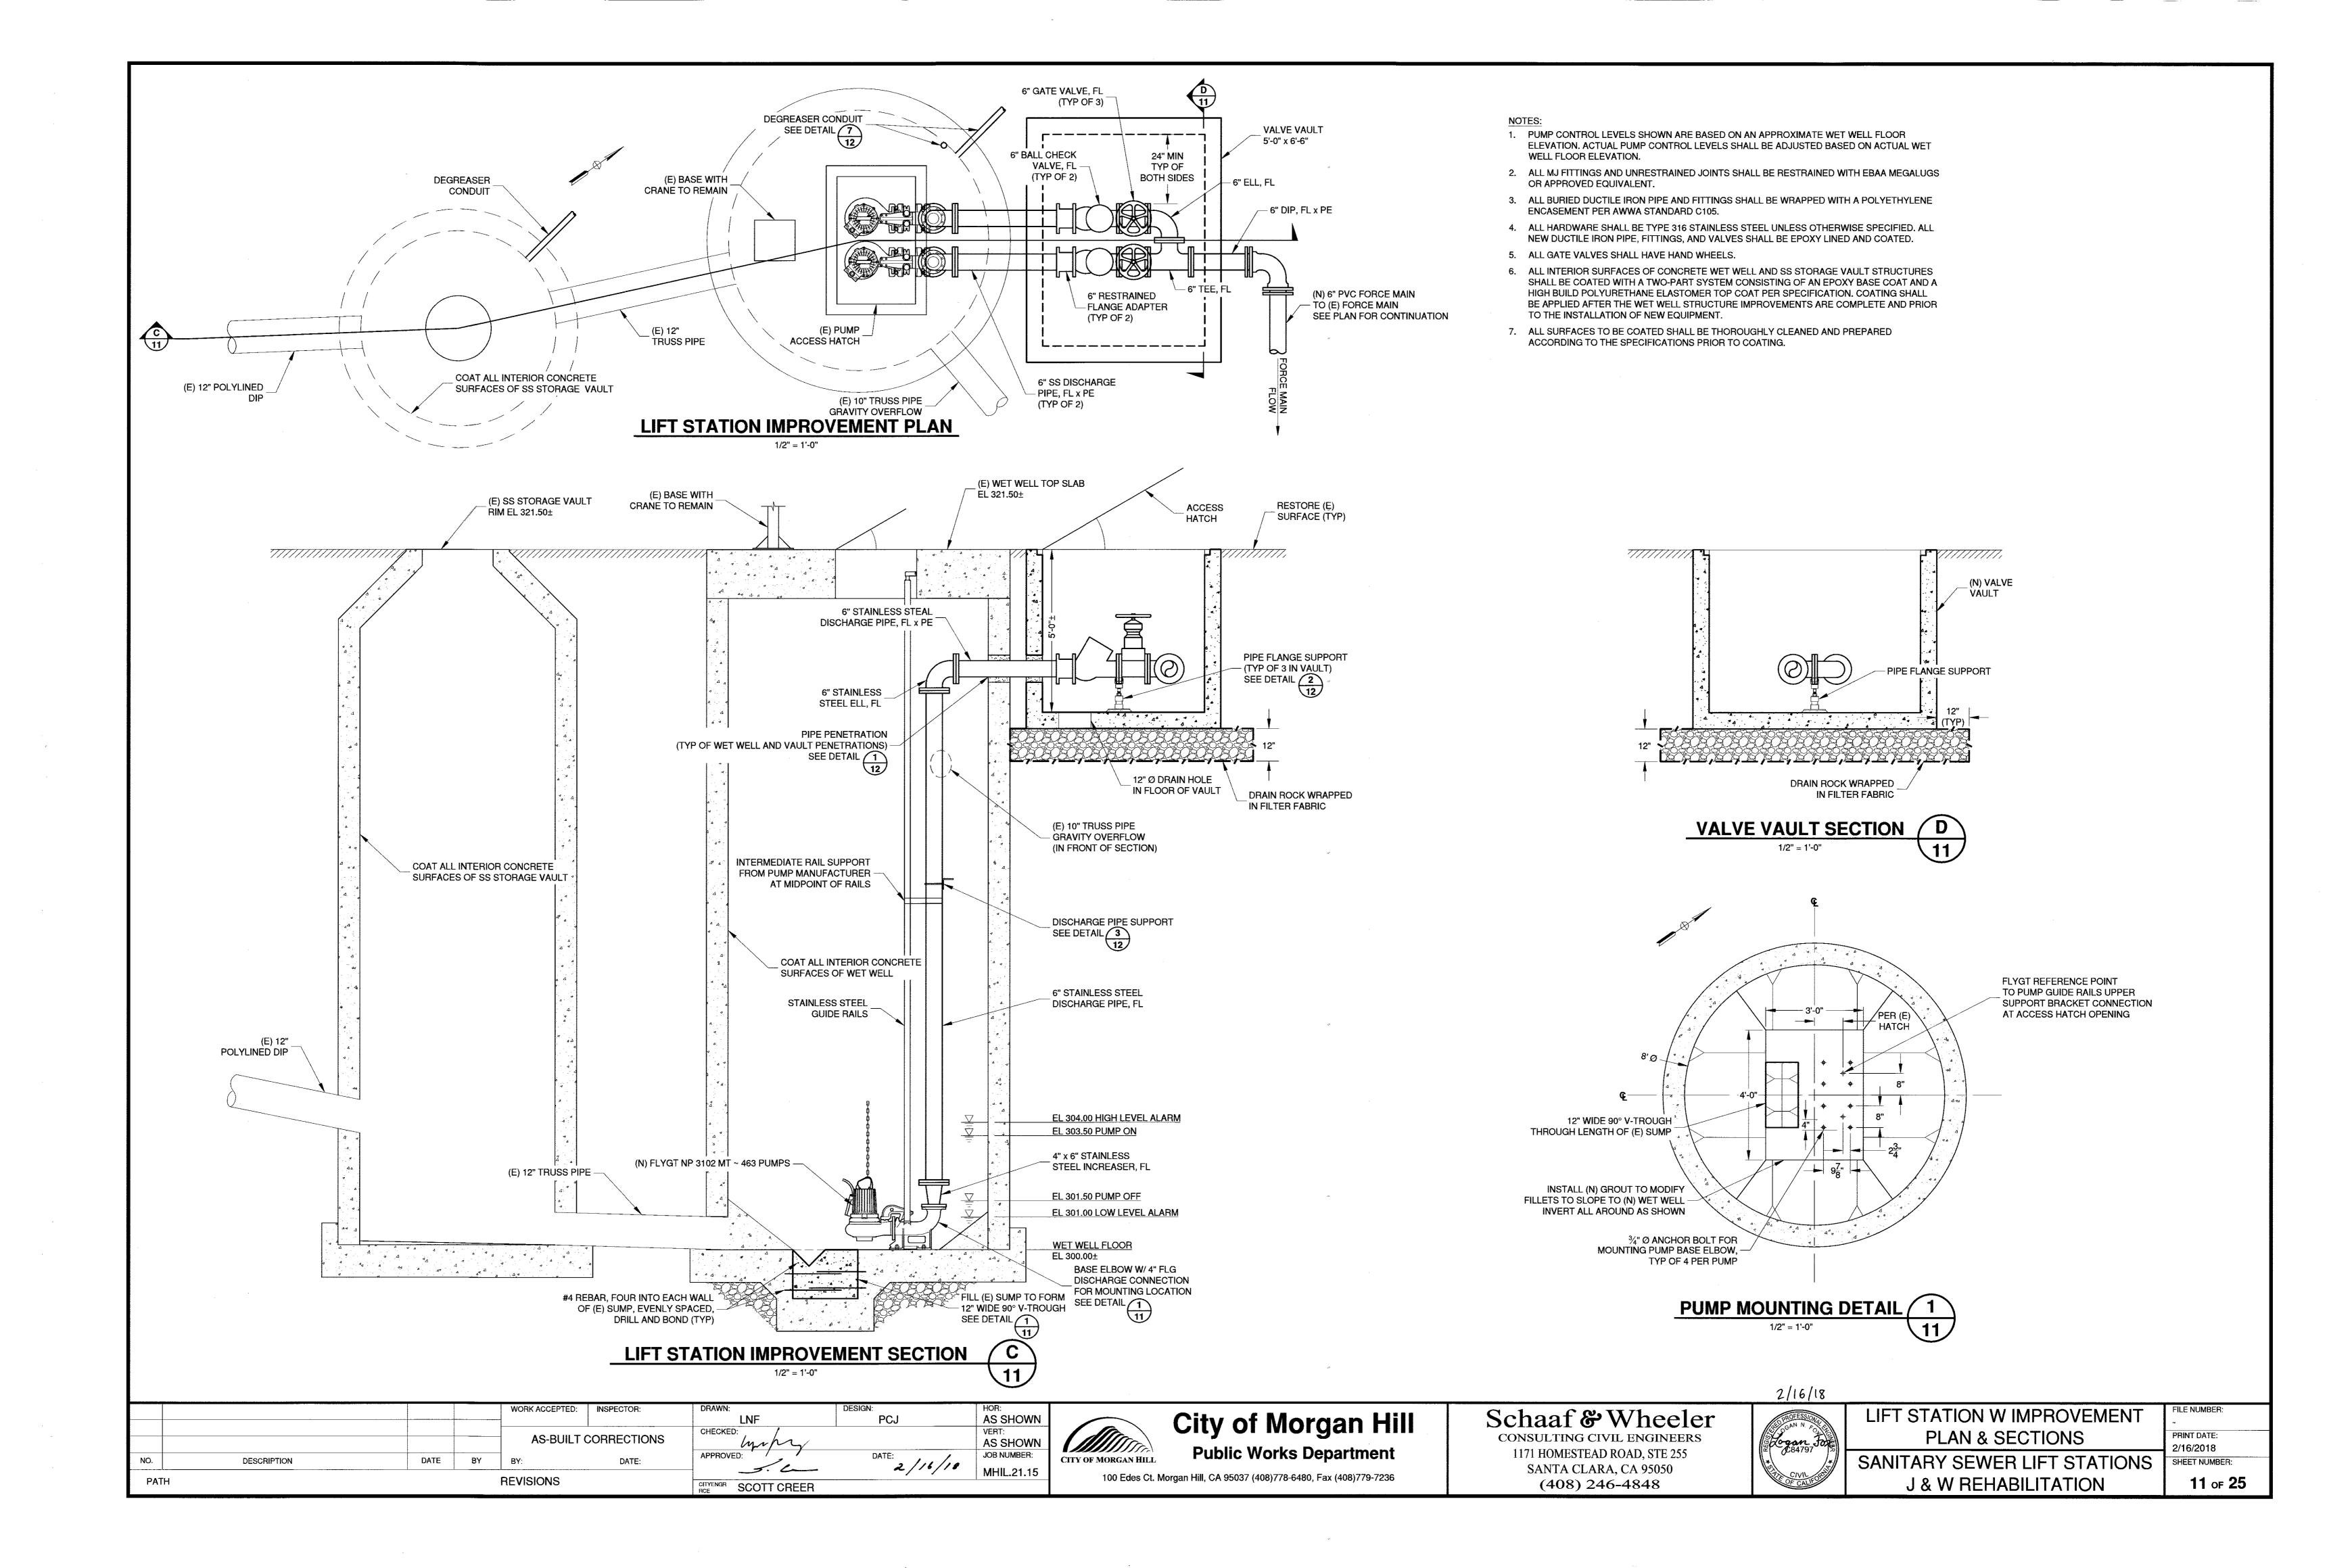
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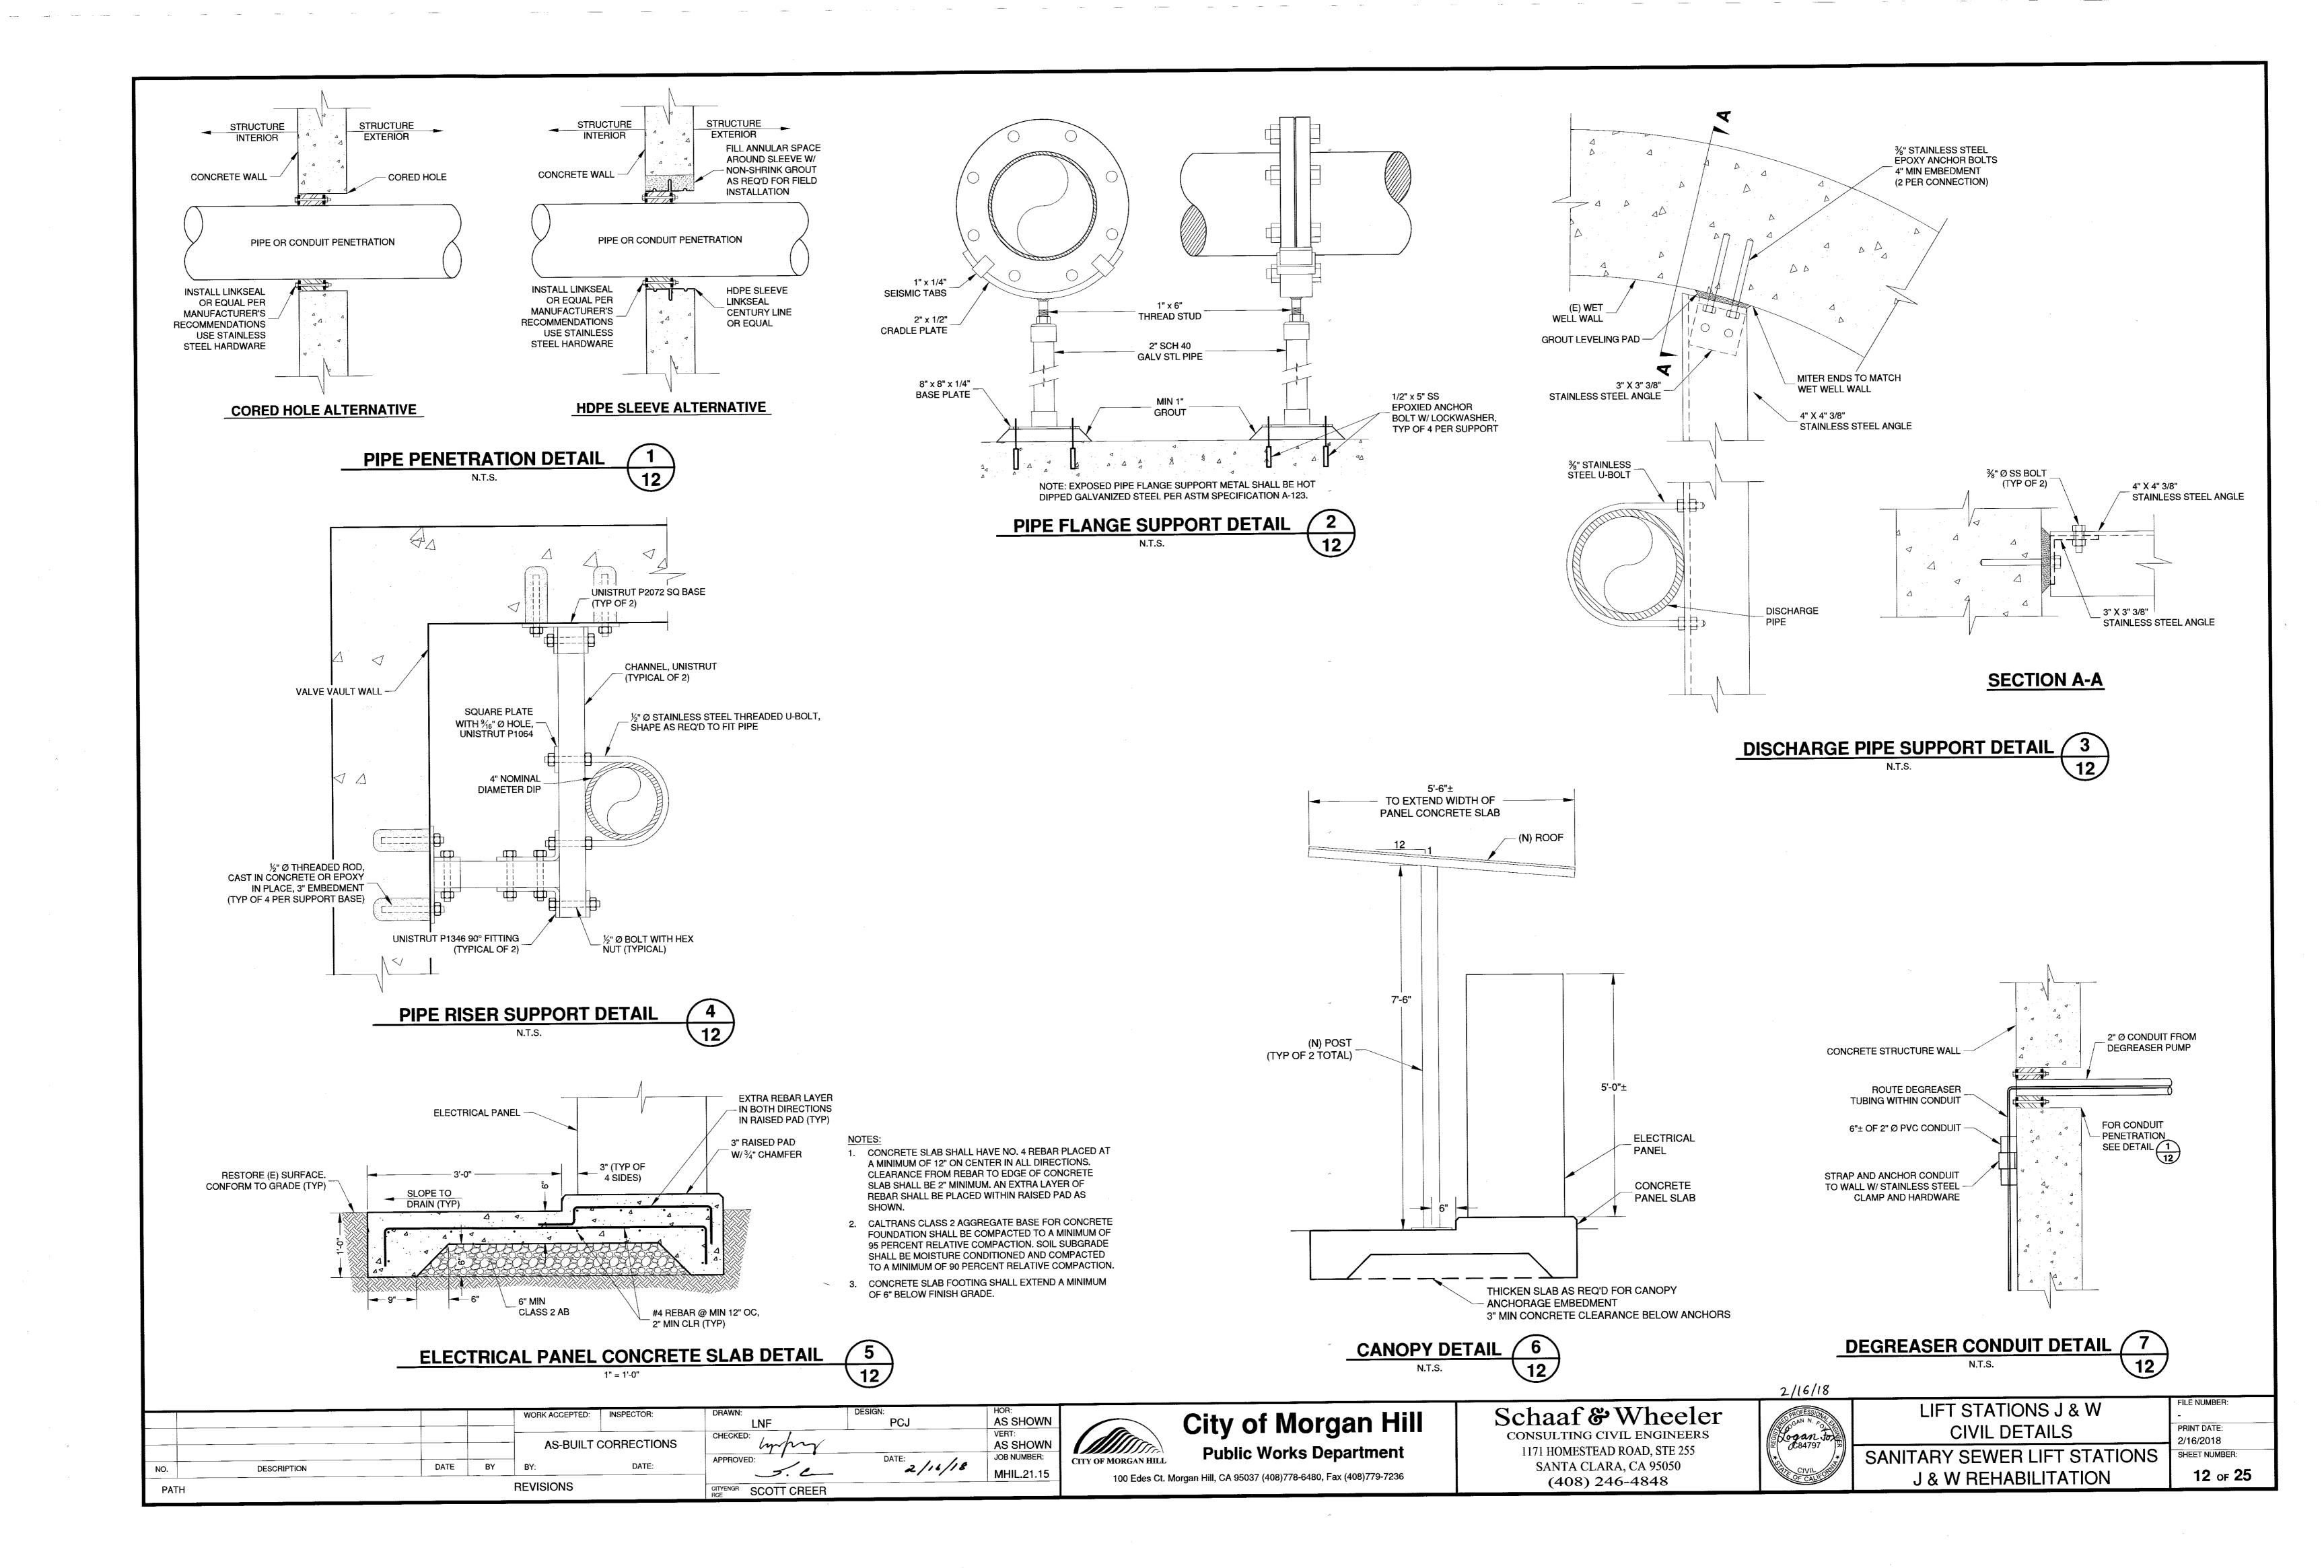


LIFT STATION W
DEMOLITION SECTION
SANITARY SEWER LIFT STATIONS
J & W REHABILITATION

FILE NUMBER:
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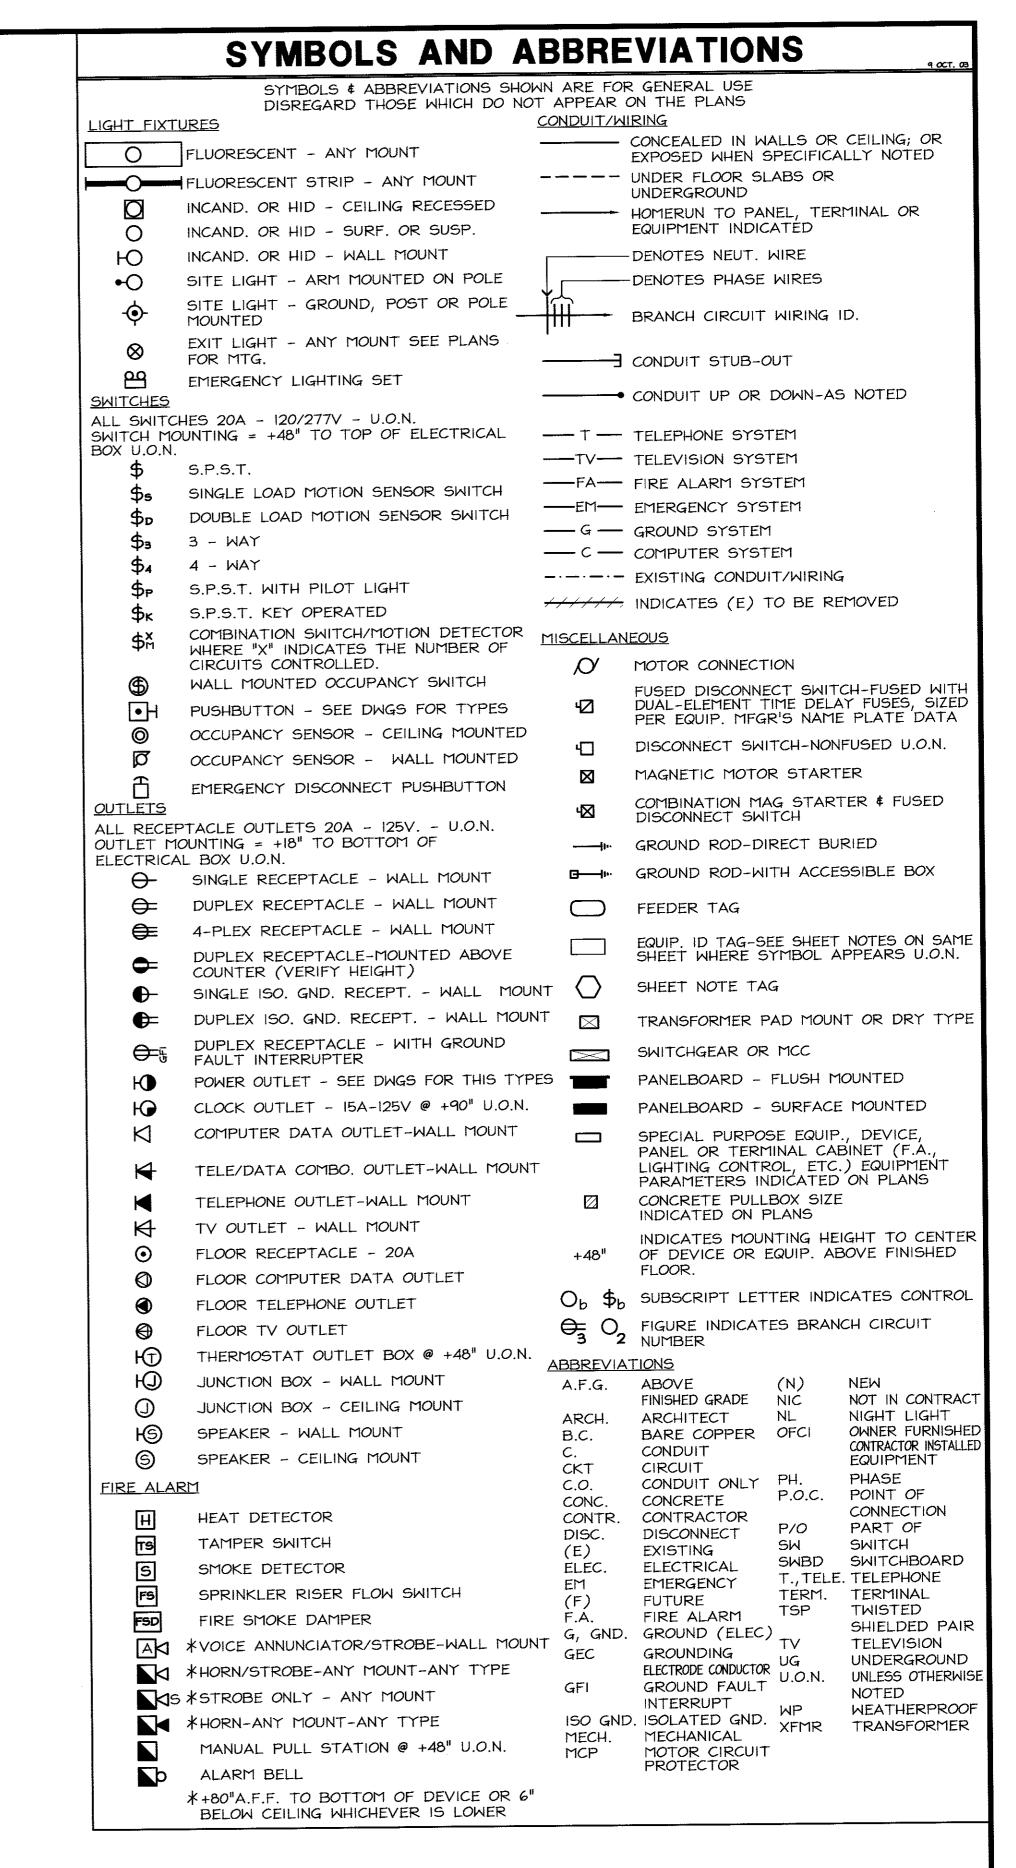



LIGHT FIXTURE SCHEDULE

FIXTURES NOTES:

- 1. ALL FLUORESCENT LIGHT FIXTURE BALLASTS SHALL BE ELECTRONIC TYPE, 15% TOTAL HARMONIC DISTORTION MAX., "ADVANCE MARK V" OR MEGNATEK/UNIVERSAL
- 2. ALL FLUORESCENT LIGHT FIXTURE LAMPS SHALL BE ENERGY SAVING 3500 K, 80 CRI MINIMUM, U.O.N.
- 3. ALL RECESSED INCANDESCENT LIGHT FIXTURES SHALL BE U.L APPROVED FOR ZERO CLEARANCE INSULATION COVER WHEN INSTALLED IN INSULATED CEILINGS.
- 4. ALL FLUORESCENT BALLASTS (AND ASSOC. FIXTS.) SHALL HAVE MANUFACTURER'S CERTIFICATION OF COMPLIANCE WITH CALIFORNIA ENERGY COMMISION STANDARDS.

LOAD	TYPE	DESCRIPTION	LAMPS	MANUFACTURES
(WATTS)	A	POLE MOUNTED LED FLOODLIGHT; DIE-CAST ALUMINUM HOUSING; TYPE III WIDE DISTRIBUTION; CLEAR TEMPERED GLASS LENS; 4000°K; 70 CRI; 5797 LUMENS; DIE-CAST ALUMINUM SLIPFITTER 5° INCREMENTS OF ADJUSTMENT; CARBON BRONZE POLYESTER POWDER COAT PAINT; 120/277V.	SUPPLIED WITH FIXTURE	LUMARK NIGHT FALCON SERIES OR APPROVED EQUAL



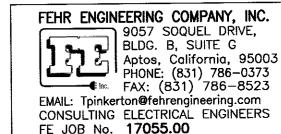


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City of Morgan Hill


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SYMBOLS	S & ABB	REVIAT	IONS
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FILE NUMBER: PRINT DATE: 2/16/2018 SANITARY SEWER LIFT STATIONS SHEET NUMBER: E1.0 13 of 25 J & W REHABILITATION



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JOB NUMBER:

2/16/18 MHIL.21.15

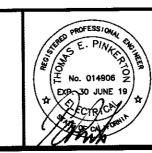DESCRIPTION

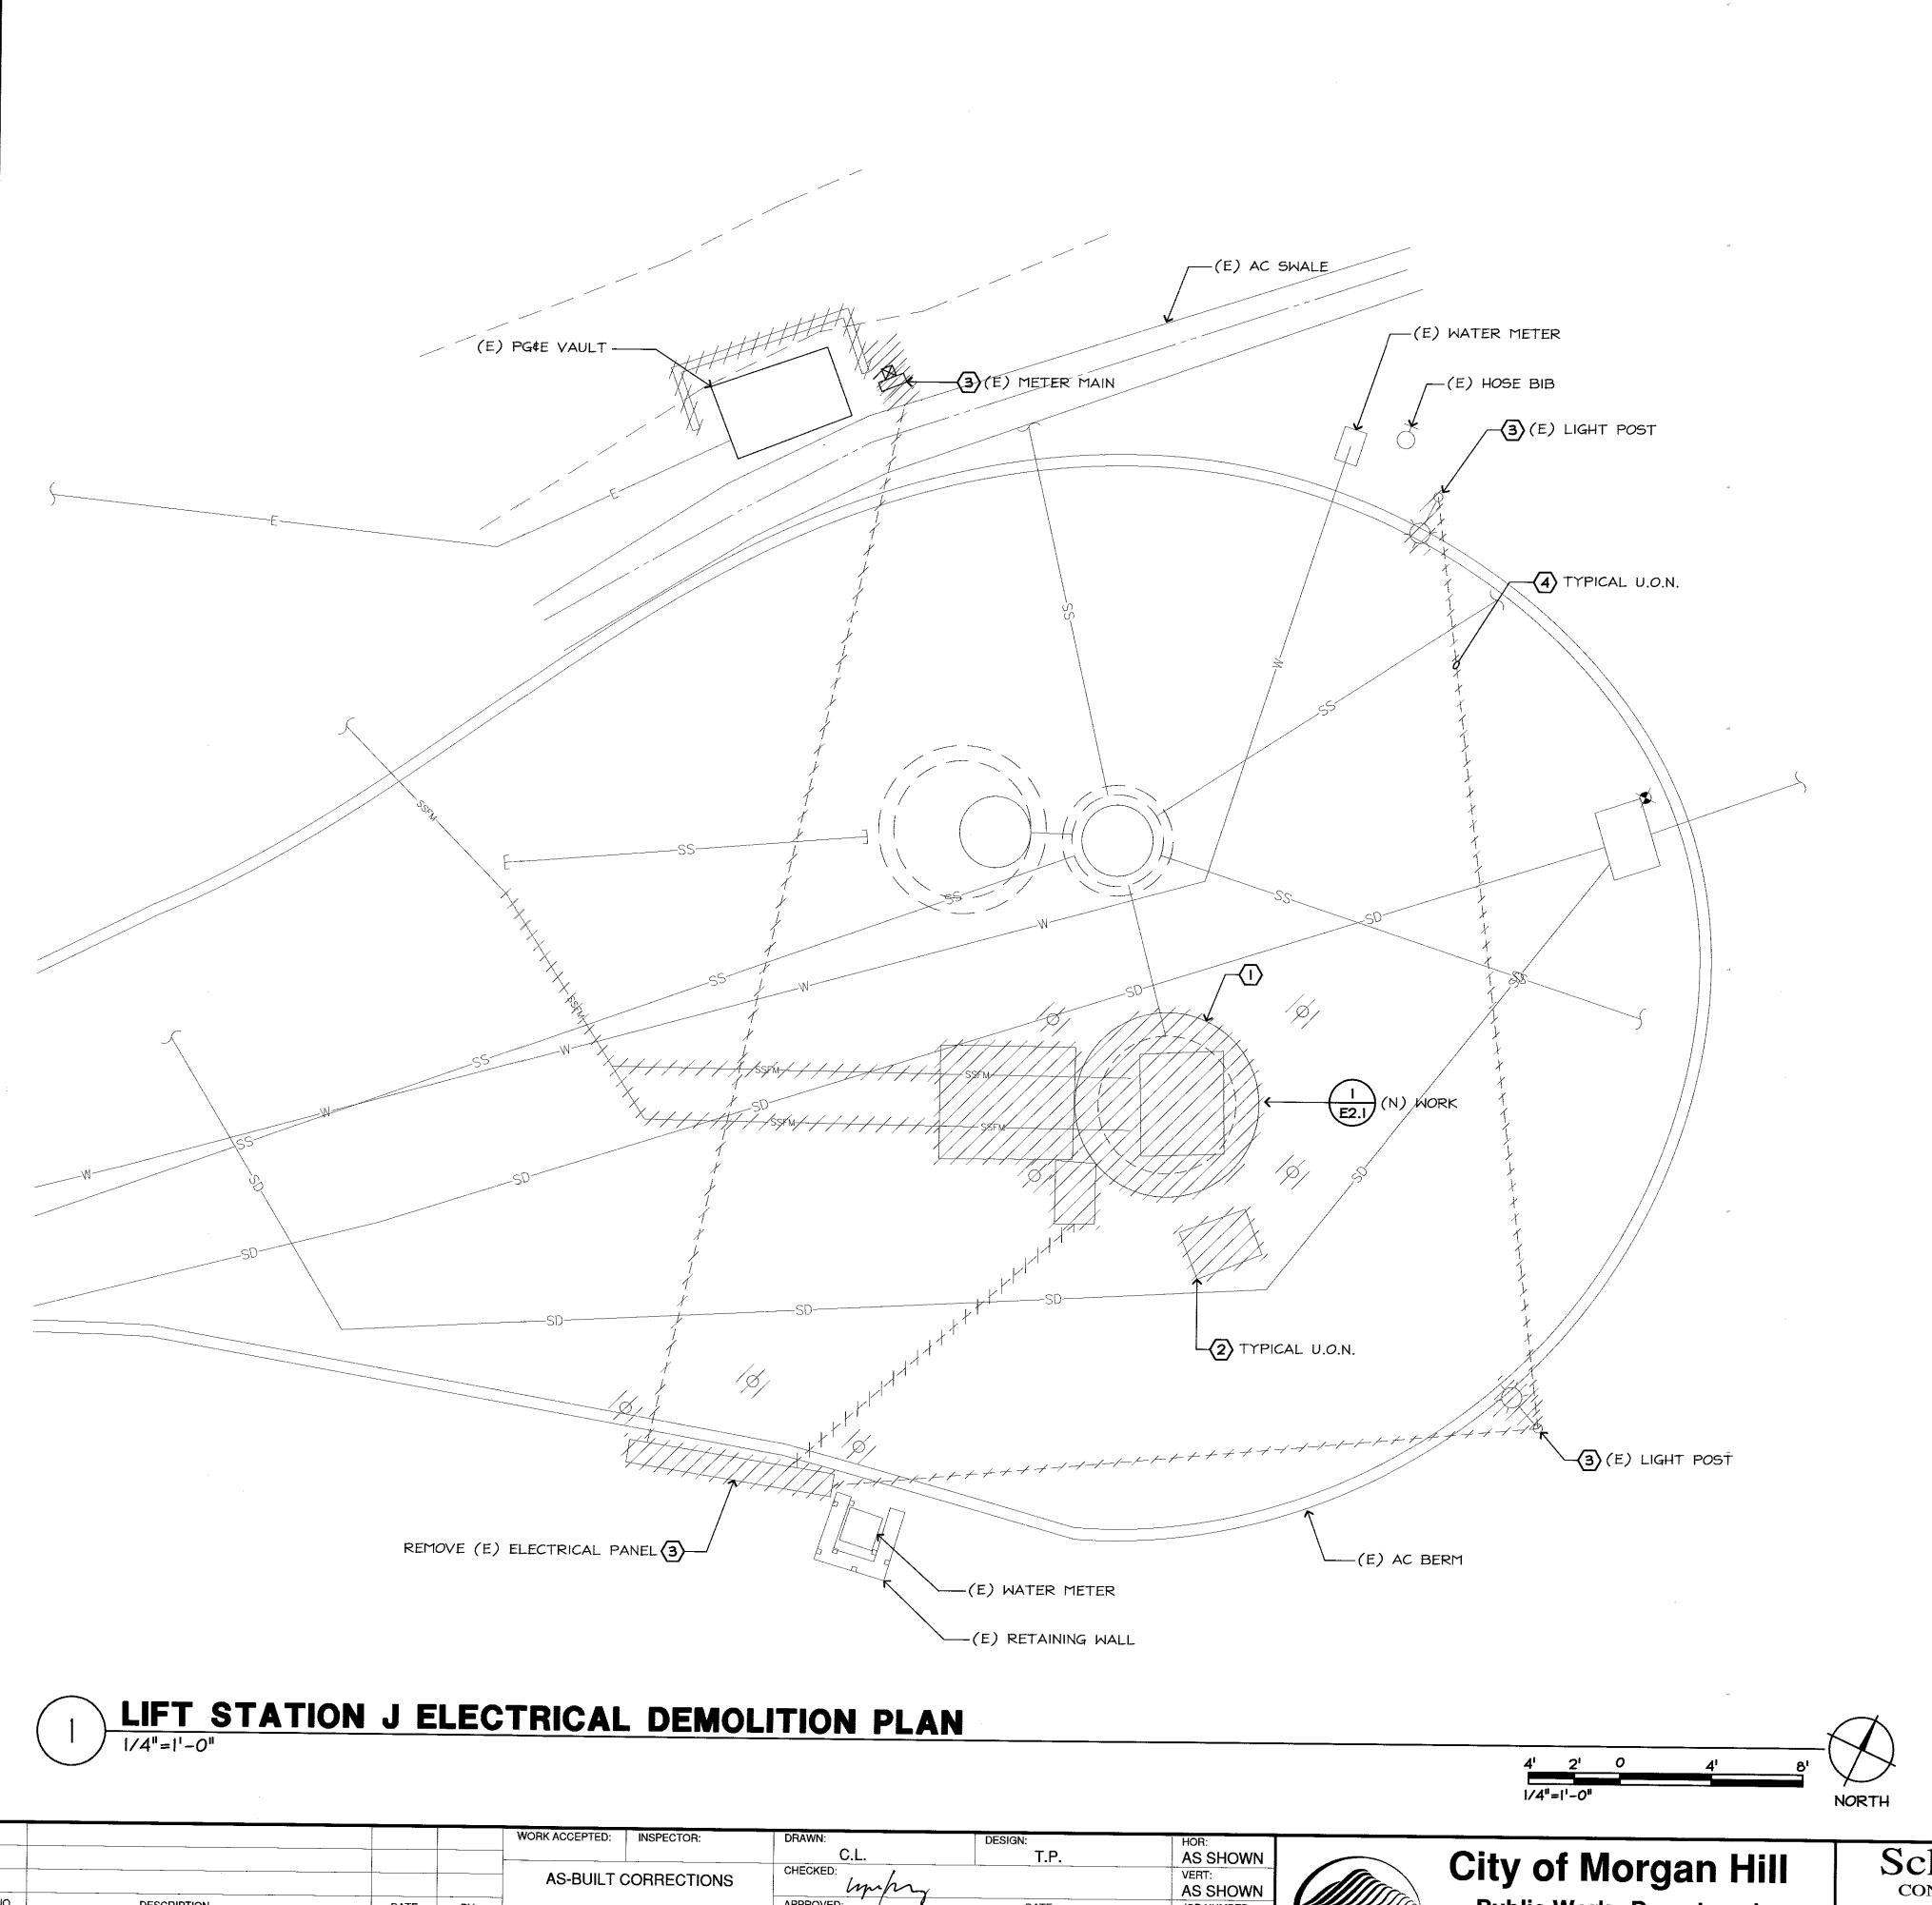PATH

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REVISIONS

○ SHEET NOTES

- I. DISCONNECT & DEMOLISH ELECTRICAL EQUIPMENT IN WET WELL; COORDINATE WITH CIVIL WORK.
- 2. DEMOLISHED UNDER CIVIL PLANS; COORDINATE.
- 3. DISCONNECT AND DEMOLISH EQUIPMENT.
- 4. REMOVE (E) UNDERGROUND CIRCUIT; ABANDON CONDUIT IN PLACE.

FEHR ENGINEERING COMPANY, INC.

9057 SOQUEL DRIVE,
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Aptos, California, 95003
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FAX: (831) 786-8523
EMAIL: Tpinkerton@fehrengineering.com
CONSULTING ELECTRICAL ENGINEERS
FE JOB No. 17055.00

Schaaf & Wheeler **Public Works Department** CITY OF MORGAN HILL


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LIFT STATION J **ELECTRICAL DEMOLITION PLAN** SANITARY SEWER LIFT STATIONS J & W REHABILITATION

PRINT DATE: 2/16/2018 SHEET NUMBER: **E2.0** 14 of 25



○ SHEET NOTES

- 1. COORDINATE (N) WORK WITH CIVIL PLANS.
- 2. CONCRETE PULLBOX 22" X 12" I.D. WITH TRAFFIC RATED LID; LABEL LID "SIGNAL"; SEE DETAIL 1/E2.2.
- 3. CONCRETE PULLBOX 22" X 12" I.D. WITH TRAFFIC RATED LID; LABEL LID "POWER"; SEE DETAIL 1/E2.2.
- 4. DEGREASER RESERVOIR; SEE DETAIL 1/E3.2.
- 5. 2"C.O. PROVIDED UNDER CIVIL PLANS; COORDINATE.
- 6. (N) GENERATOR; SEE ELECTRICAL SPECIFICATION.
- 7. ROUTE CIRCUIT VIA LIGHTING CONTROLS IN POWER PEDESTAL.

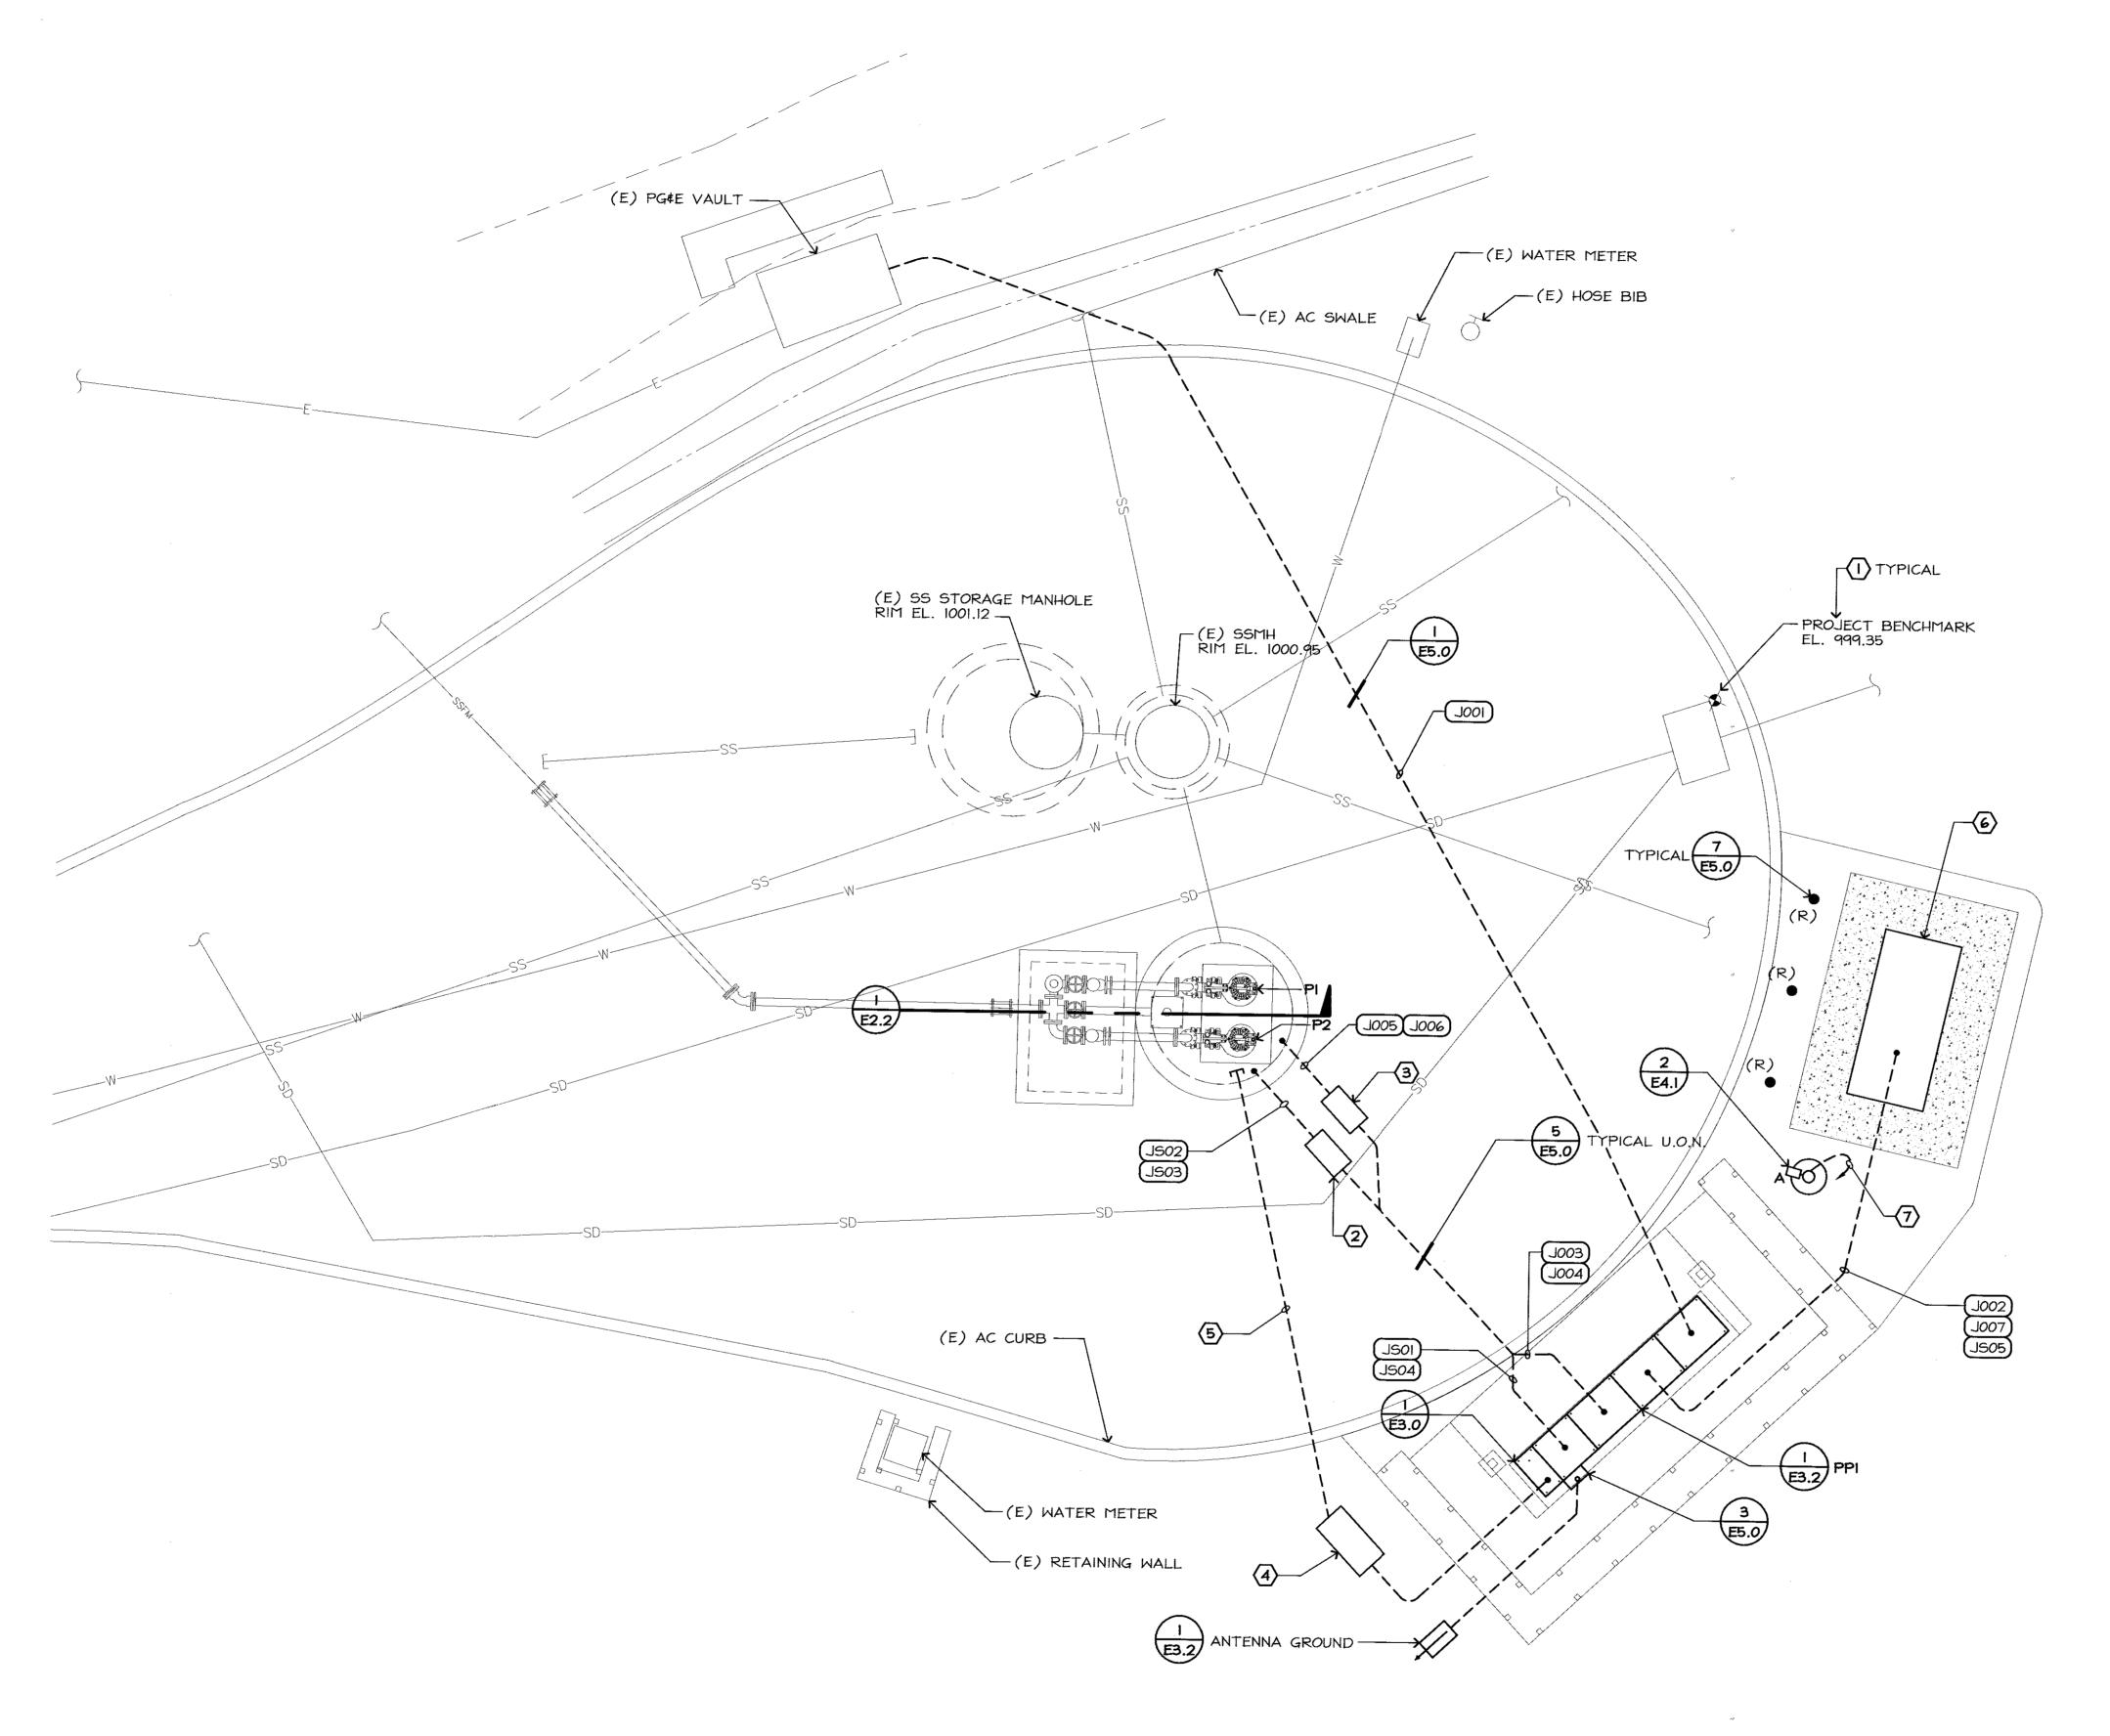LIFT STATION J ELECTRICAL IMPROVEMENT PLAN

PATH

C.L. T.P. AS SHOWN CHECKED: AS-BUILT CORRECTIONS AS SHOWN

JOB NUMBER: DESCRIPTION DATE BY APPROVED: MHIL.21.15 **REVISIONS**

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NORTH

FEHR ENGINEERING COMPANY, INC.

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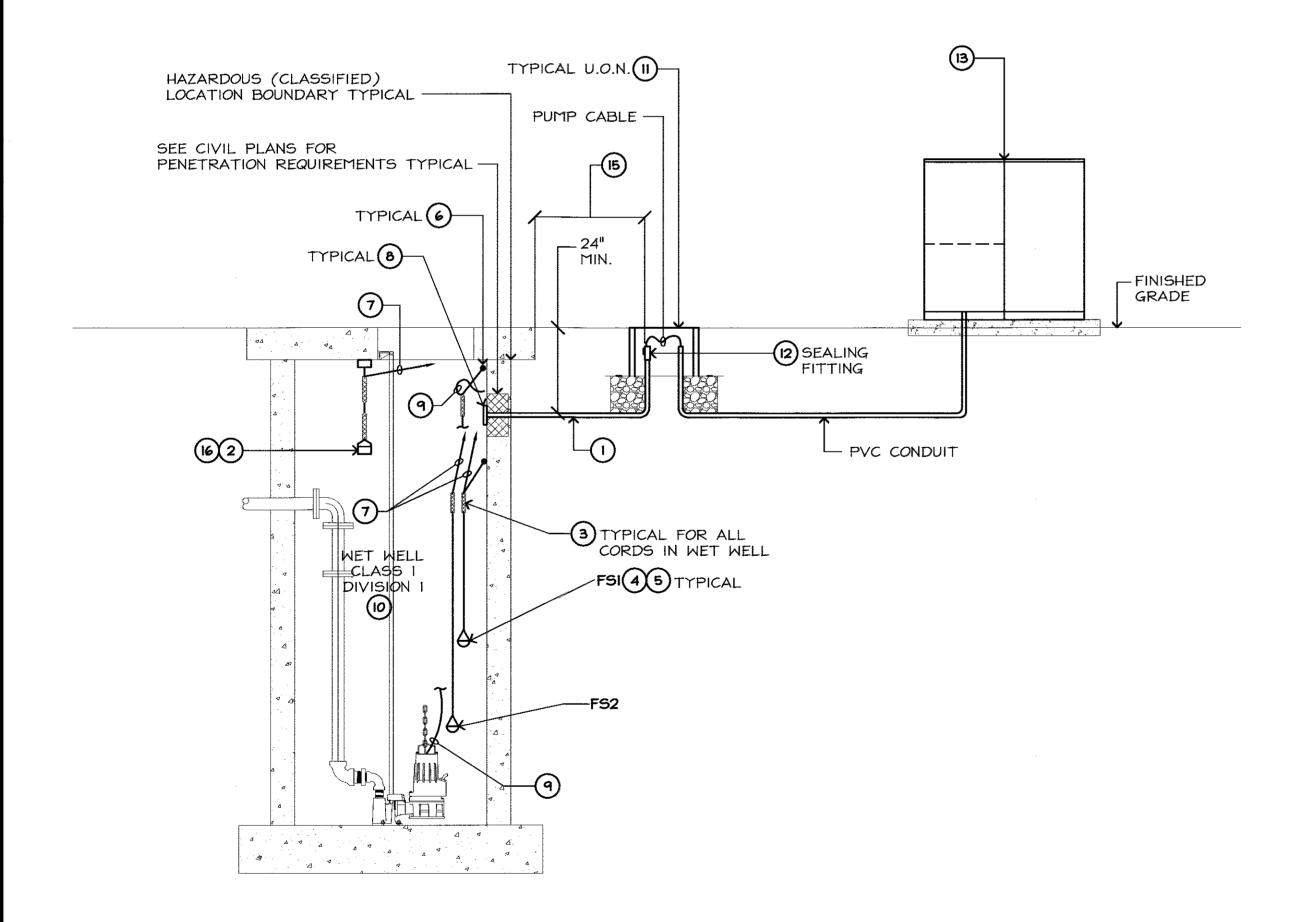
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CONSULTING ELECTRICAL ENGINEERS
FE JOB No. 17055.00 LIFT STATION J

ELECTRICAL IMPROVEMENT PLAN SANITARY SEWER LIFT STATIONS J & W REHABILITATION

2/16/2018 SHEET NUMBER: E2.1 15 of 25

DETAIL NOTES:

- PVC COATED GALVANIZED RIGID STEEL CONDUITS (POWER AND SIGNAL) TO PULLBOX; EXACT ROUTE OF CONDUIT TO BE DETERMINED IN FIELD.
- 2. ULTRASONIC LEVEL TRANSDUCER; RANGE 1-26 FEET; -20°C-65°C; BEAM ANGLE 10°-12°; 4-20mA SIGNAL; TRANSDUCER COMPATIBLE WITH CONTROLS PLC; EMERSON OR APPROVED EQUAL.
- 3. CABLE SUPPORT GRIP, HEAVY DUTY STAINLESS STEEL, OFFSET EYE SPLIT MESH. ROD CLOSING "KELLUMS" OR APPROVED EQUAL
- 4. COORDINATE FS MOUNTING HEIGHT WITH CIVIL PLANS.
- 5. FLOAT SWITCH; MECHANICAL TILT FLOAT SWITCH; ENM-10 LEVEL REGULATOR BY ITT FLYGT. PROVIDE WITH INTRINSICALLY SAFE INTERFACE DEVICE.
- 6. SECURE CABLE GRIP TO WET WELL STRUCTURE.
- 7. SIGNAL CIRCUIT THROUGH WETWELL WALL; PENETRATE WALL AS SHOWN FOR POWER CORD.
- 8. BELL ADAPTER SET FLUSH INTO GROUT OF WALL PENETRATION.
- 9. (N) PUMP POWER CORD; SEE STATION SINGLE LINE DIAGRAM FOR CONNECTION REQUIREMENTS.
- 10. WET WELL IS A HAZARDOUS (CLASSIFIED) LOCATION; CLASS I DIVISION I; ELECTRICAL INSTALLATION SHALL COMPLY ACCORDINGLY.
- 11. INGROUND CONCRETE PULLBOX (POWER PULLBOX SHOWN; SIGNAL PULLBOX SIMILAR); SEE SITE PLAN FOR SIZE; SEE DETAIL 6/E5.0 FOR PULLBOX INSTALLATION REQUIREMENT.
- 12. EYS SEALING FITTING; SIZED FOR CONDUIT SEE SINGLE LINE DIAGRAM; SEAL ALL CONDUITS LEAVING THE WETWELL.
- 13. POWER PEDESTAL; SEE STATION POWER PEDESTAL DETAIL.
- 14. DETAIL REPRESENTS A GENERIC WETWELL INSTALLATION APPLICABLE TO EACH SPECIFIC WETWELL; SEE SPECIFIC WETWELL ELEVATION ON CIVIL PLANS FOR EXACT REQUIREMENTS.
- 15. SEAL CONDUIT WITHIN 10' OF HAZARDOUS (CLASSIFIED) LOCATION BOUNDARY.
- 16. LOCATE ULTRASONIC TRANSDUCER FOR CLEAR LINE OF SIGHT TO LIQUID LEVEL.




LIFT STATIONS J & W WETWELL ELECTRICAL ELEVATION (4) NO SCALE

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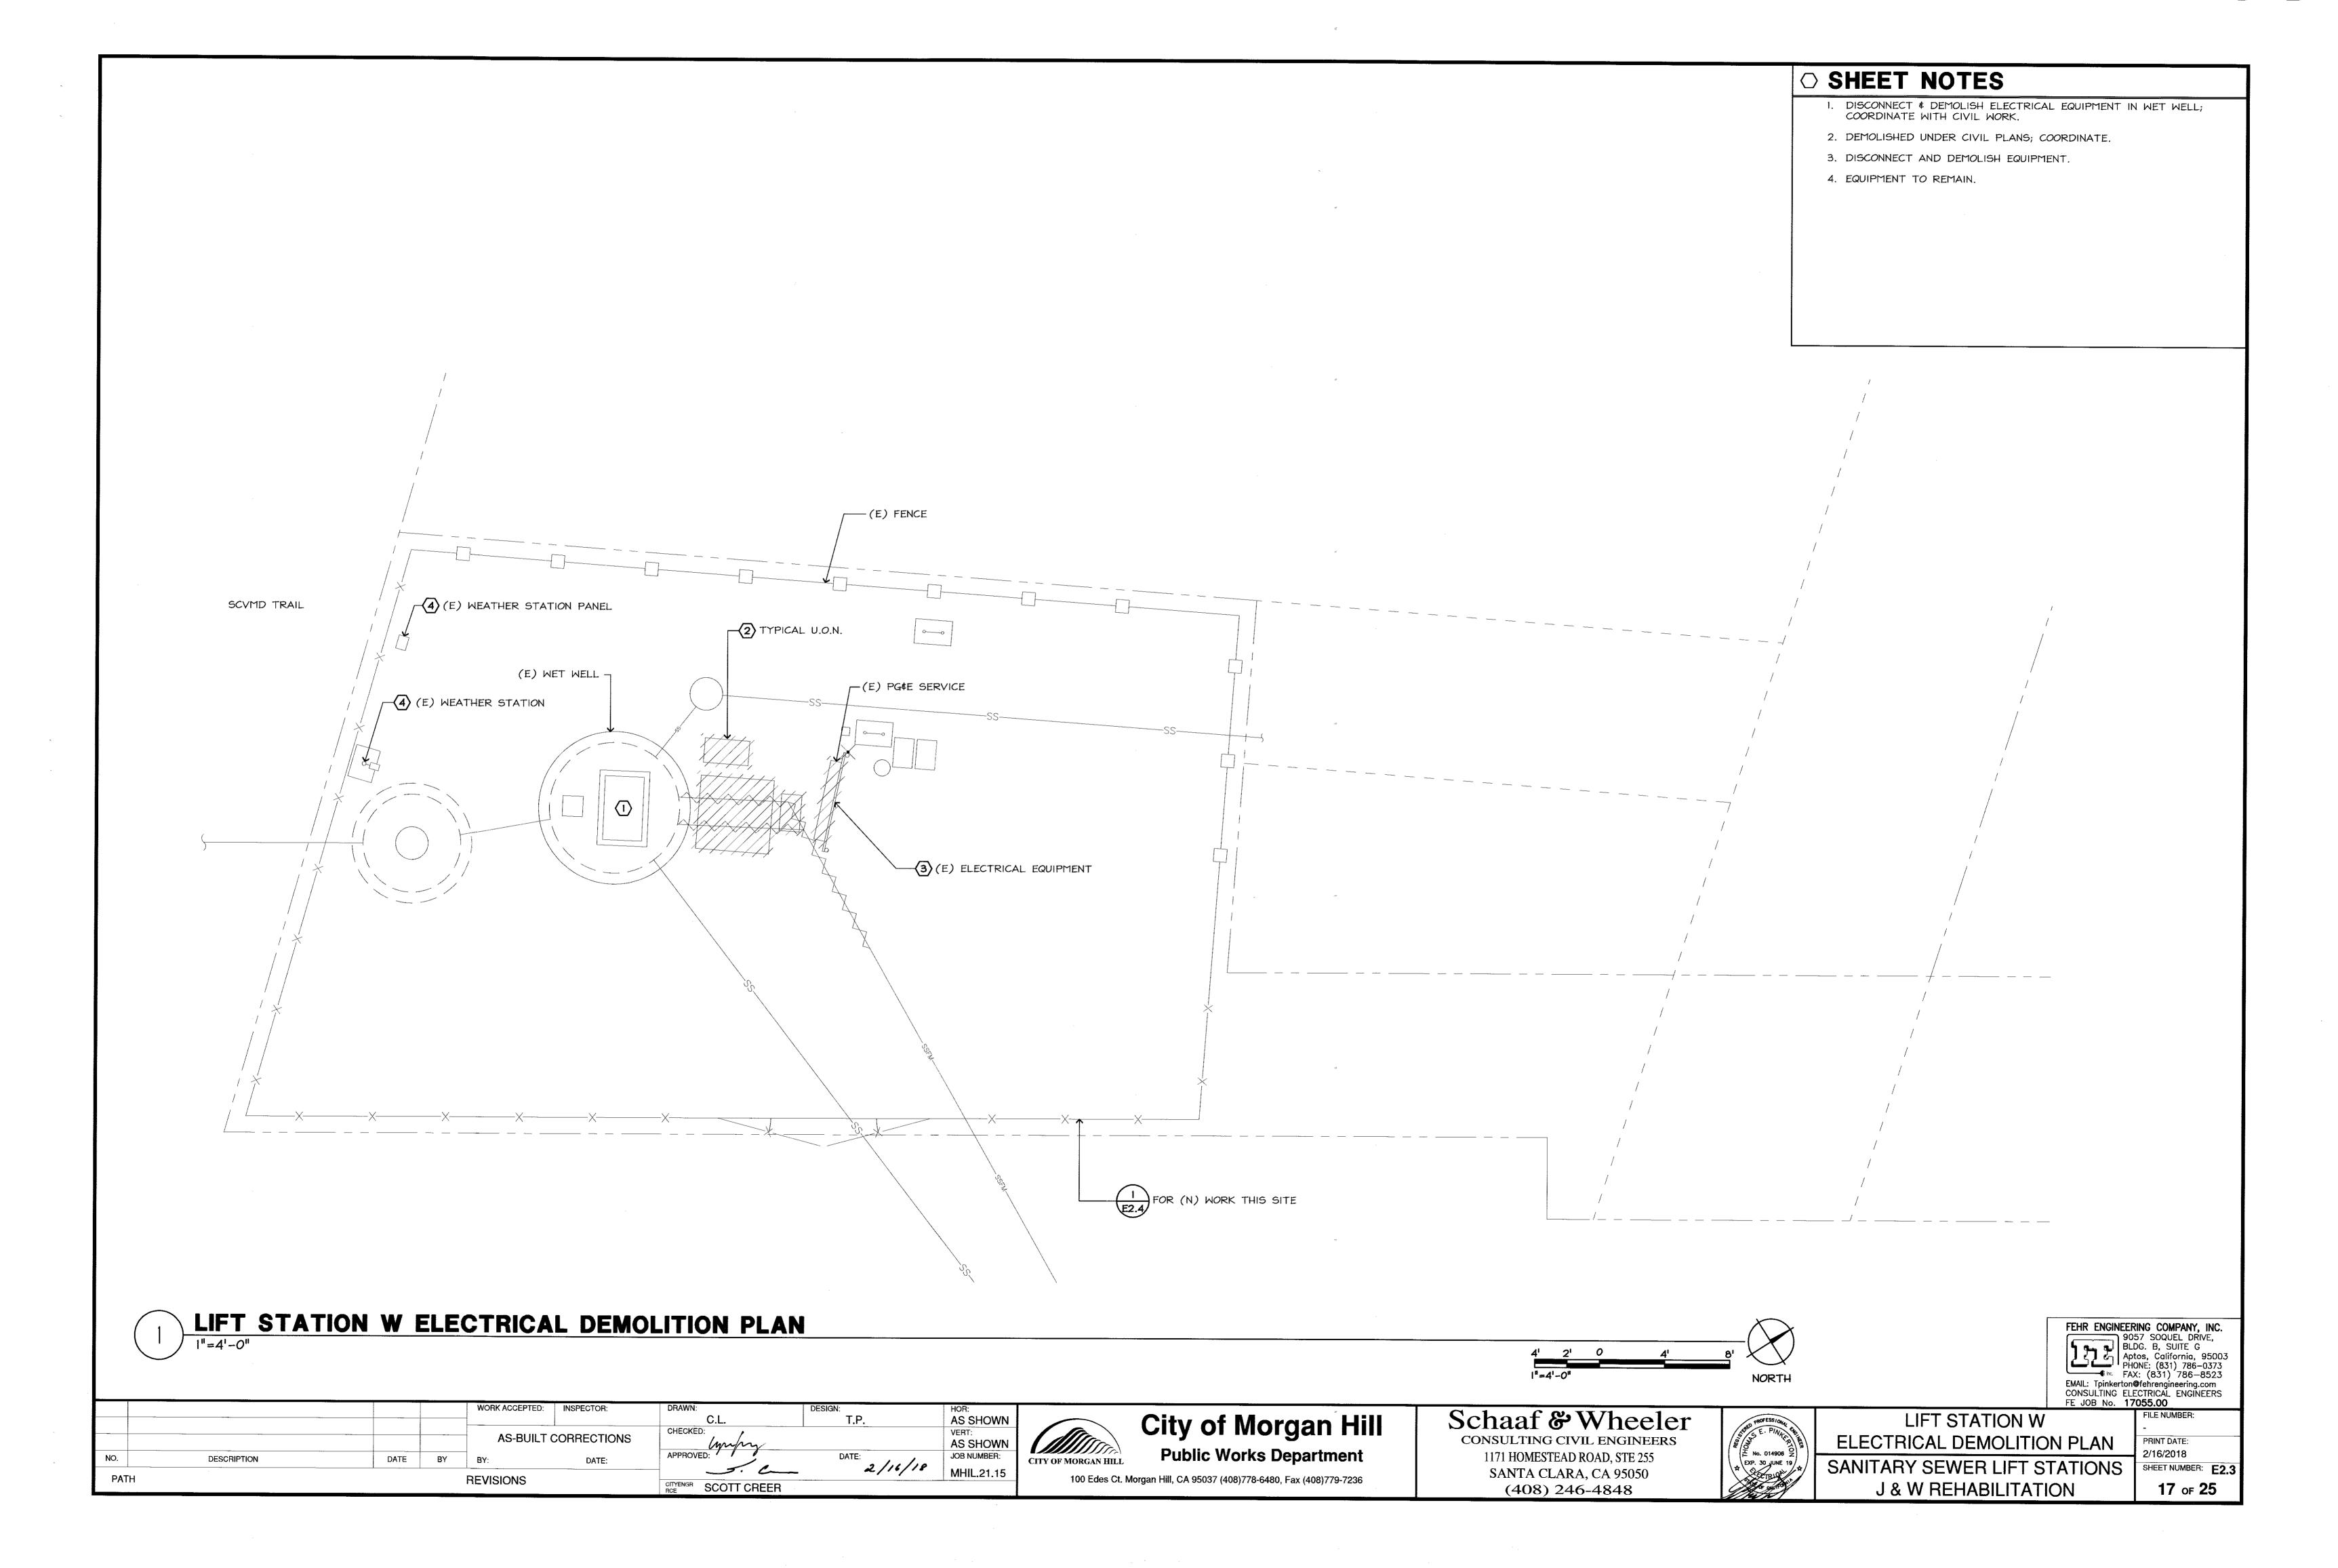



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(408) 246-4848

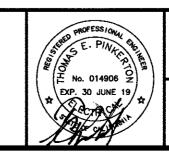

FEHR ENGINEERING COMPANY, INC. 9057 SOQUEL DRIVE, BLDG. B, SUITE G Aptos, California, 95003 PHONE: (831) 786-0373 FAX: (831) 786-8523 EMAIL: Tpinkerton@fehrengineering.com CONSULTING ELECTRICAL ENGINEERS FE JOB No. 17055.00 FILE NUMBER: PRINT DATE:

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WETWELL ELECTRICAL ELEVATION	PRINT DATE:
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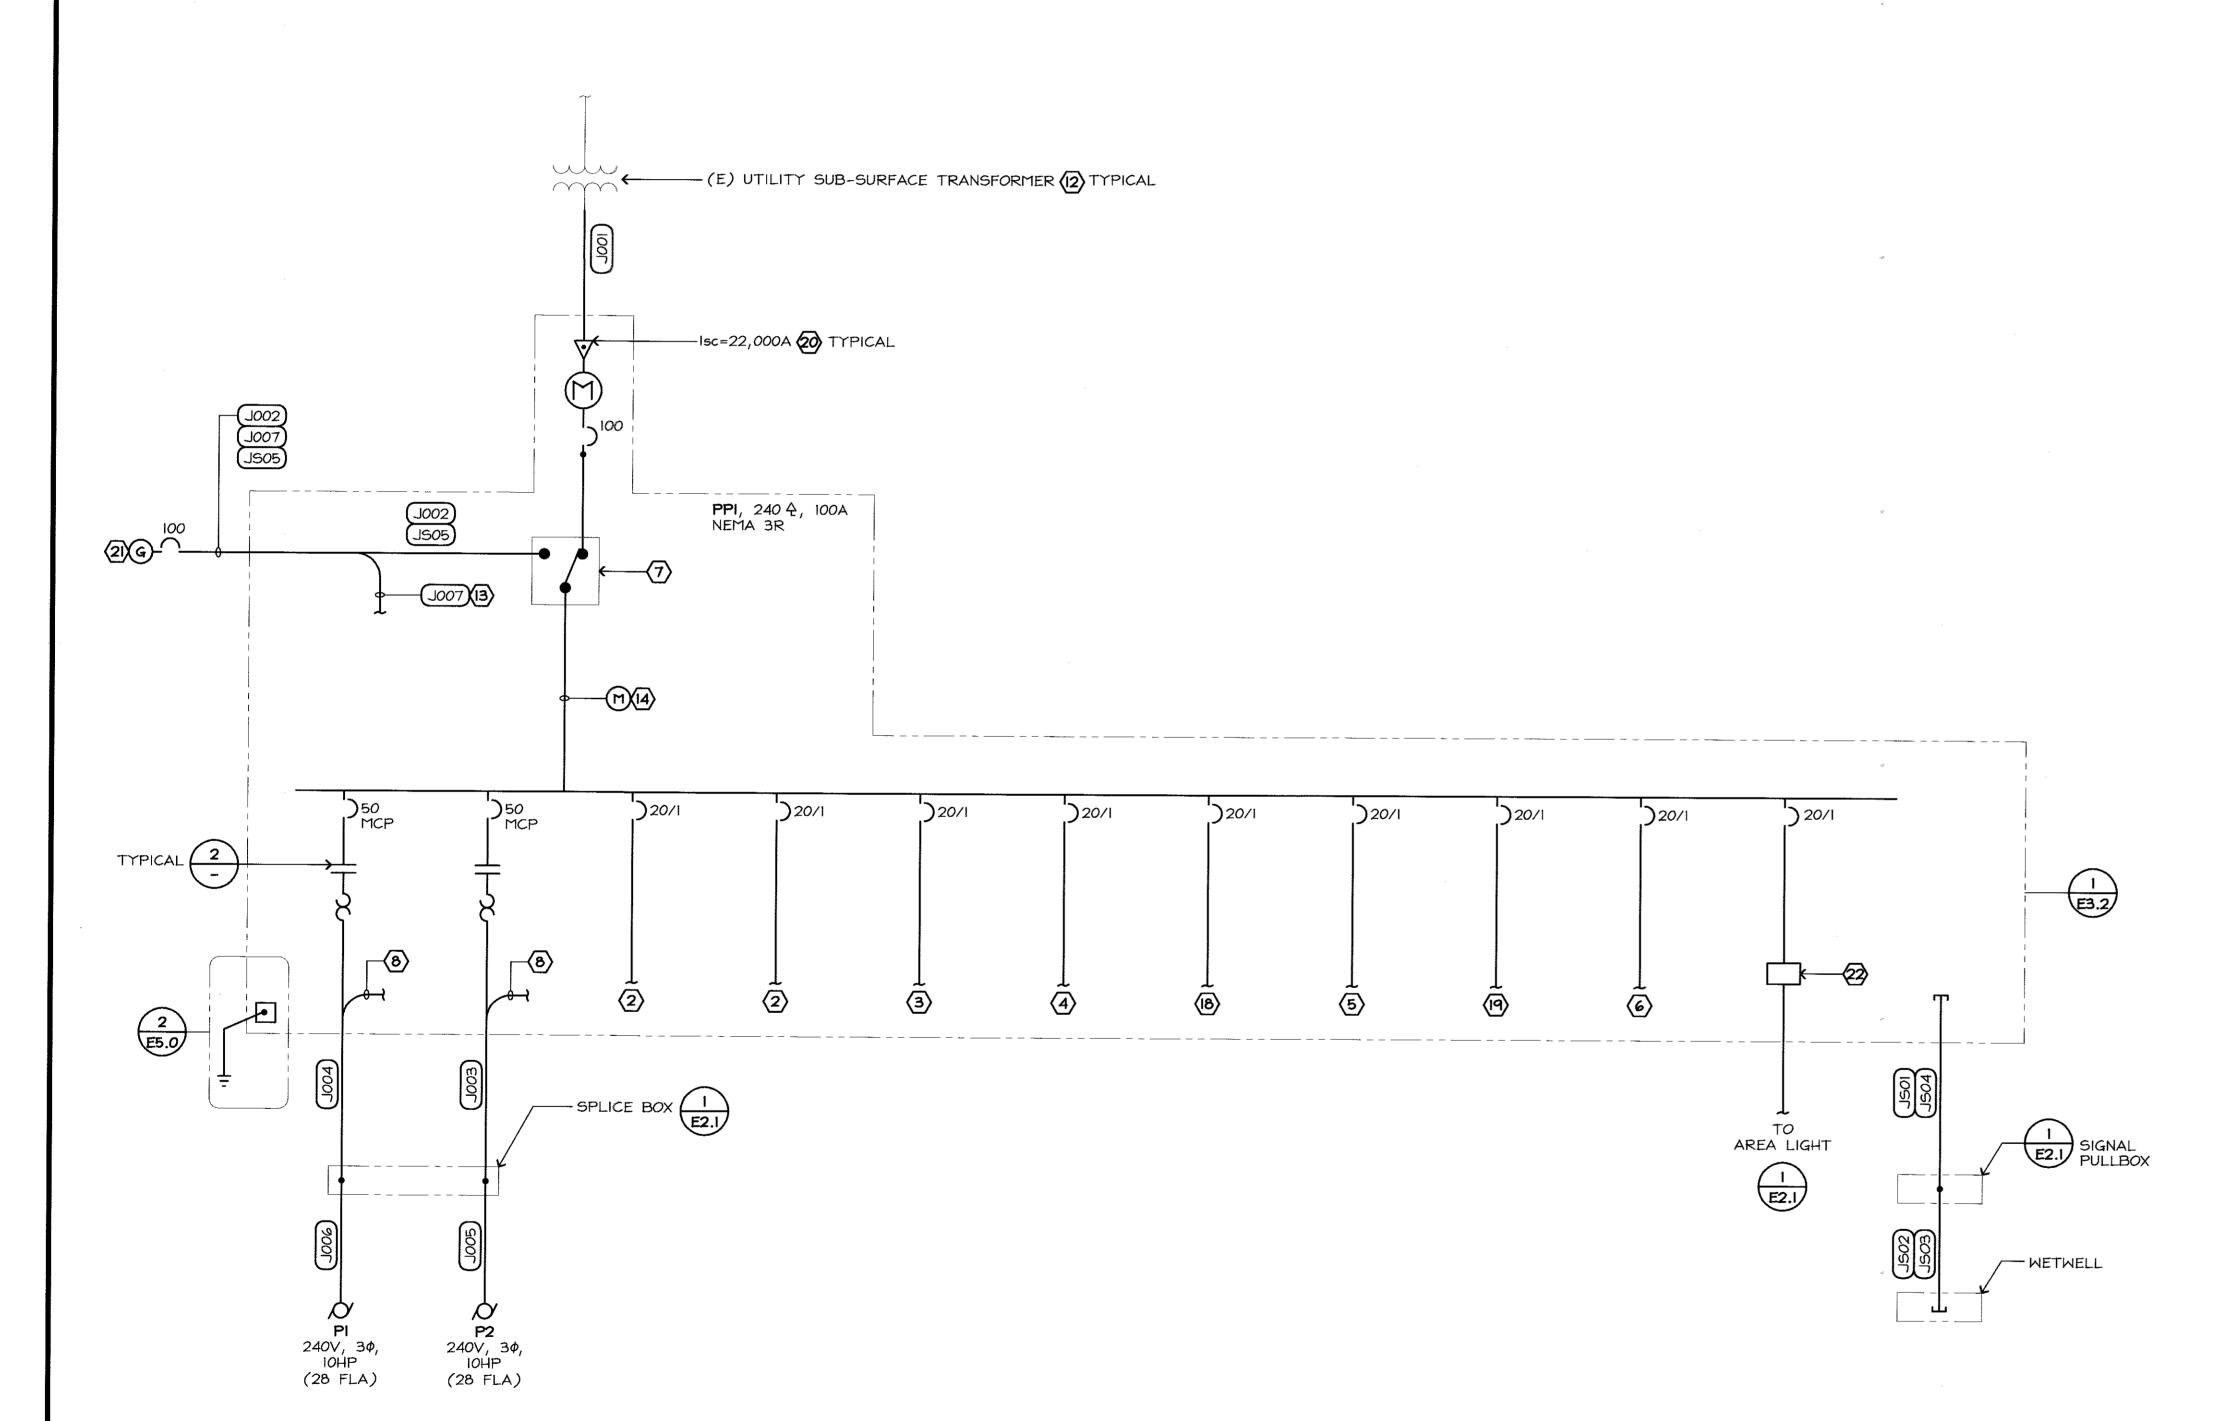
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JS05

3/4°C., 6#14

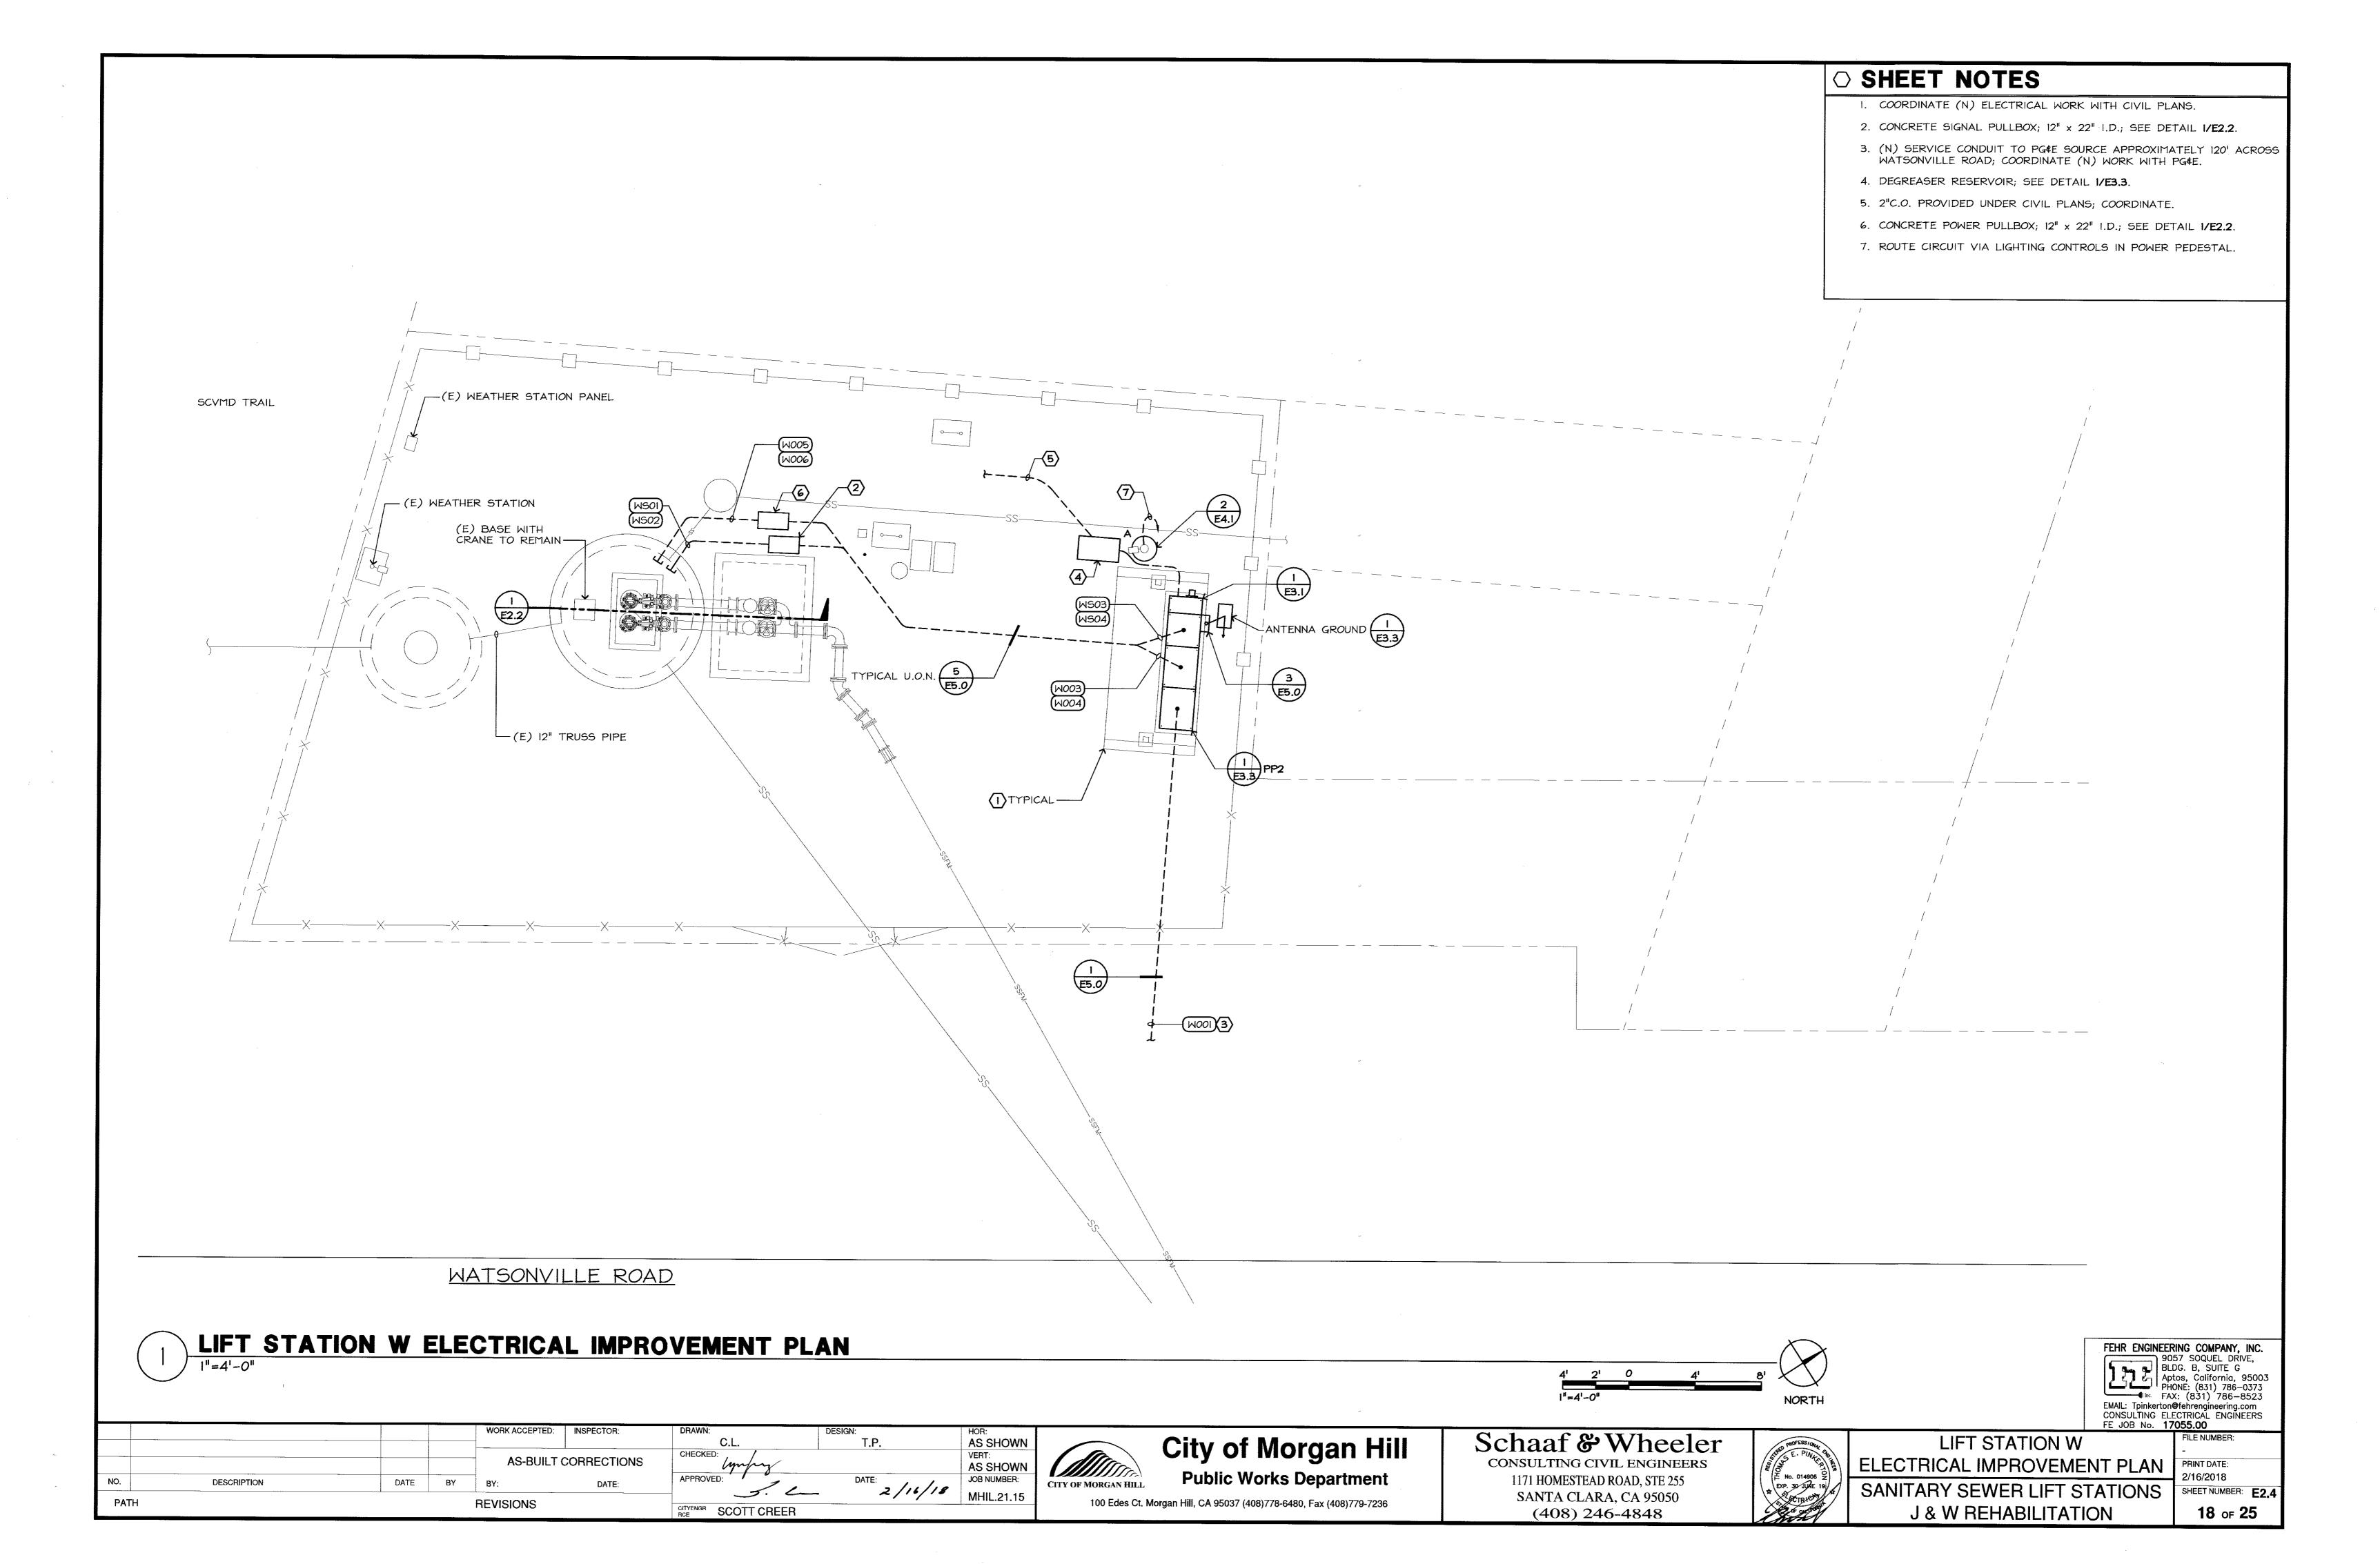
3/1°C., 2#12, 1#12 GND.

GENERATOR START SIGNAL



○ SHEET NOTES

- I. PROVIDE OVERLOAD INDICATING LAMP ADJACENT TO PUMP RUNNING
- 2. 120V CIRCUIT TO CONTROL SECTION.
- 3. 120V CIRCUIT TO DEGREASER SECTION.
- 4. PEDESTAL LIGHTS.
- 5. PEDESTAL HEATERS.
- 6. PROVIDE 3 SPARE CIRCUIT BREAKERS.
- 7. AUTOMATIC TRANSFER SWITCH; SEE ELECTRICAL SPECIFICATION.
- 8. SIGNAL CONDUCTORS TO MINI CAS CONTROLS.
- 9. PUMP CABLES PROVIDED AS PART OF PUMPS; COORDINATE EXACT LENGTH OF CABLES WITH PUMP VENDOR; CABLES INCLUDE PUMP POWER CONDUCTOR & MINI CAS SIGNAL CONDUCTORS.
- 10. CONDUIT FOR ULTRASONIC SIGNAL CABLE; ELECTRICAL CONTRACTOR SHALL PROVIDE \$ INSTALL CABLES AS REQUIRED FOR SIGNAL CONNECTION.
- II. MOMENTARY CONTACT TEST SWITCH.
- 12. ELECTRICAL CONTRACTOR SHALL COORDINATE WITH PGEE FOR ALL UTILITY RELATED WORK PRIOR TO BEGINNING PROJECT INSTALLATION.
- 13. CIRCUIT TO POWER SOURCE FOR GENERATOR BATTERY CHARGER \$ BLOCK HEATER.
- 14. POWER MONITOR PROVIDED WITH CURRENT TRANSFORMERS (CT); MONITORS VOLTAGE & CURRENT LEVELS; PROVIDE SIGNAL TO PLC FOR 30 DAY LOAD PROFILING WITH SCADA ALARM FOR 30 DAY HIGH # LOW KW READING; ELECTRO INDUSTRIES/GAUGE TECH SHARK OR EQUAL; PROVIDE SUBMITTAL.
- 15. POWER CONDUCTORS & MINI CAS SIGNAL CONDUCTORS.
- 16. CONDUIT & CONDUCTOR FOR FLOAT SWITCH SIGNAL CONNECTION; SPLICE CONDUCTORS IN PULLBOX; SEE DETAIL 1/E2.1.
- 17. CONDUIT FOR FLOAT SWITCH CABLES; ELECTRICAL CONTRACTOR SHALL PROVIDE # INSTALL CABLES AS REQUIRED FOR SIGNAL CONNECTION.
- 18. GENERATOR BLOCK HEATER.
- 19. GENERATOR BATTERY CHARGER.
- 20. RATE PEDESTAL ELEMENTS TO WITHSTAND FAULT CURRENT NOTED.
- 21. STANDBY EMERGENCY GENERATOR 40KW; 120/240V, 3¢, 4-WIRE; SEE ELECTRICAL SPECIFICATION.
- 22. AREA LIGHTING CONTROLS; DETAIL 1/E3.2.

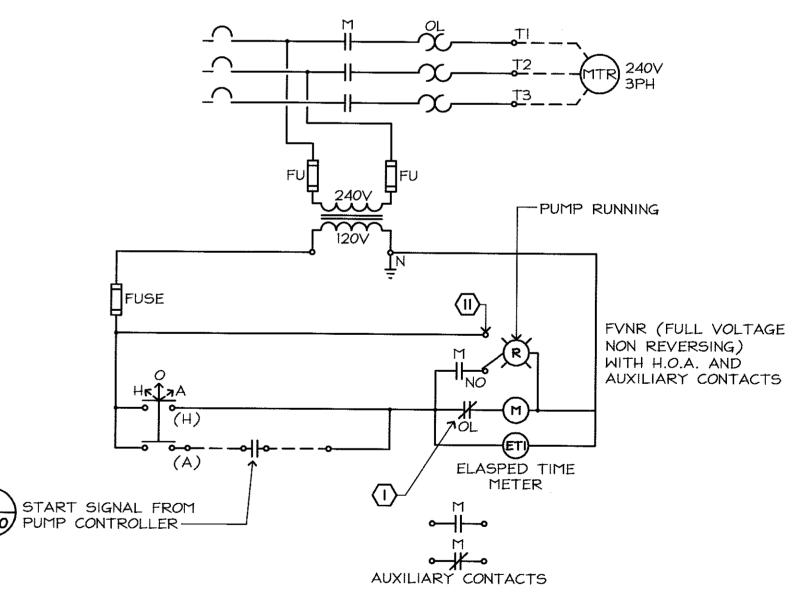

MOTOR STARTER DIAGRAM NO SCALE

LIFT STATION J SINGLE LINE DIAGRAM

Isc= AVAILABLE SHORT CIRCUIT (RMS SYM. AMPS) BASED ON 500MVA

SHORT-CIRCUIT DUTY AT SERVICE XFMR PRIMARY AND 7.5% BELOW

NOMINAL XFMR IMPEDANCES; VALUES ON LOAD-SIDE OF MAIN

SWITCHBOARD INCLUDE MOTOR CONTRIBUTION.


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CONSULTING ELECTRICAL ENGINEERS
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19 of 25

SINGLE LINE DIAGRAM PRINT DATE: 2/16/2018 SANITARY SEWER LIFT STATIONS SHEET NUMBER: E3.0 J & W REHABILITATION


GENERAL SINGLE LINE NOTES


- A. ALL ELECTRICAL SHOWN IS NEW, U.O.N.
- B. ALL CIRCUIT BREAKERS ARE 3-POLE, U.O.N.
- C. VOLTAGE DESIGNATIONS: (U.O.N.) 240-1 = 240/120V-IPH-3 WIRE 480-1 = 480V-1PH-2 WIRE
 - $240 \Delta = 240 V 3 PH 3 WIRE$ 208Y = 208/120V - 3PH - 4 WIRE480Y = 480/277V - 3PH - 4 WIRE $480 \Delta = 480 V - 3 PH - 3 WIRE$

240 € = 240/120V-3PH-4 WIRE

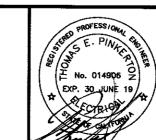- D. "KA" AT CIRCUIT BREAKERS DENOTES MINIMUM REQUIRED INTERRUPTING CAPACITY IN AMPS (x 1000).
- SPO AT BREAKER DENOTES: PROVIDE MOUNTING SPACE \$ HARDWARE FOR FUTURE 3-POLE BREAKER OF RATINGS INDICATED.
- F. Isc= AVAILABLE SHORT CIRCUIT (RMS SYM, AMPS) BASED ON 500MVA SHORT-CIRCUIT DUTY AT SERVICE XFMR PRIMARY AND 7.5% BELOW NOMINAL XFMR IMPEDANCES; VALUES ON LOAD-SIDE OF MAIN SWITCHBOARD INCLUDE MOTOR CONTRIBUTION.

	FEEDER SCHEDULE	
FDR No.	CONDUIT AND CONDUCTORS	REMARK
M001	3"C.O.	PG¢E SECONDARY
W002	4#2, I#8 GND.	
M003	³¼"C., 3#12, 1#12 GND. \$ 3#14	(5)
W004	3/4"C., 3#12, 1#12 GND. \$ 3#14	(5)
W005	1½"C., 3#12, 1#12 GND.	PUMP CABLE (9)
M006	1½°C., 3#12, 1#12 GND.	PUMP CABLE (9)
WSOI	2 ¹¹ C.	SIGNAL (0)
WS02	I ^{II} C.	SIGNAL (6)
WS03	I ^H C.	SIGNAL (6)
WS04	3 ₄ "C., 6#14	SIGNAL (17)

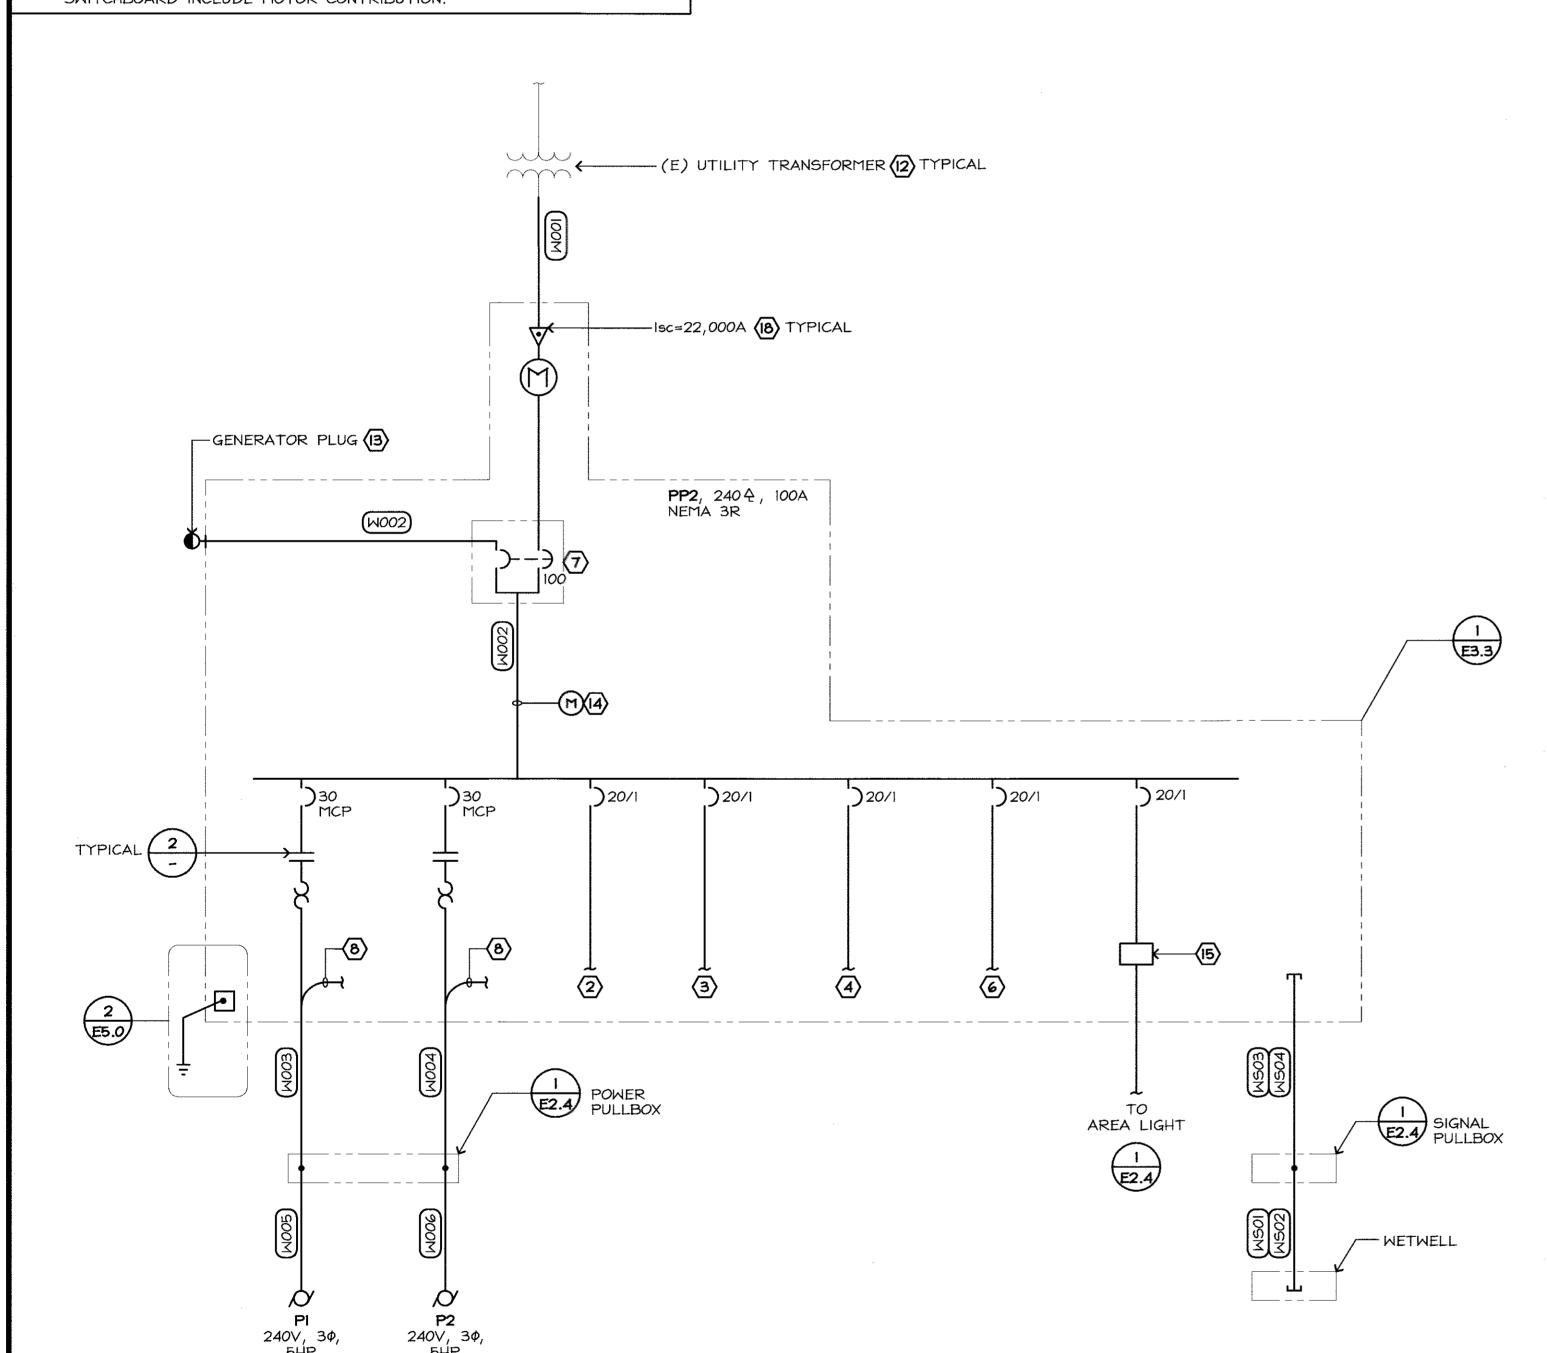

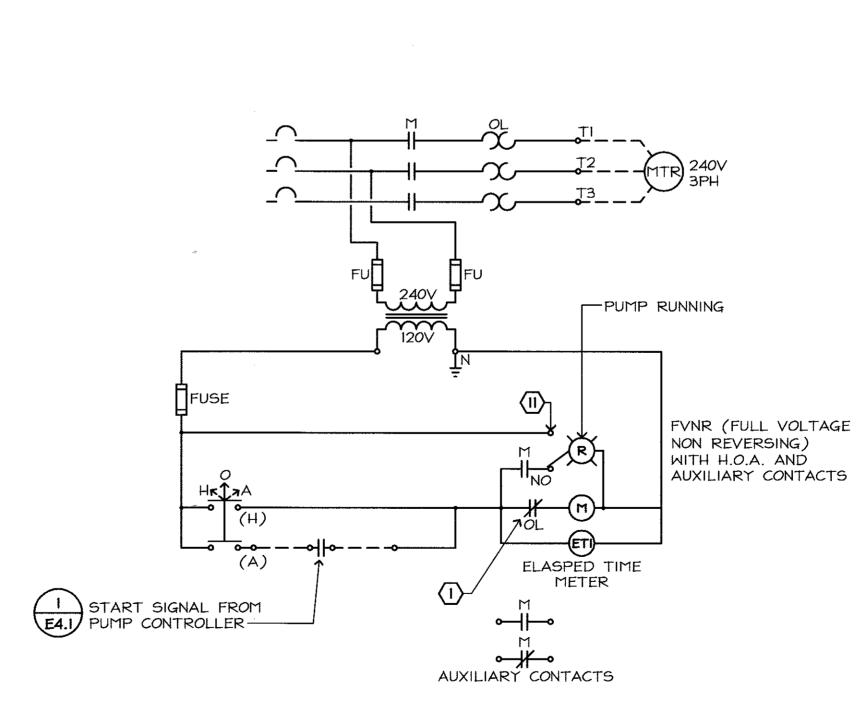

LIFT STATION W SINGLE LINE DIAGRAM NO SCALE

(15.2FLA)

(15.2FLA)

MOTOR STARTER DIAGRAM NO SCALE

FEHR ENGINEERING COMPANY, INC. BLDG. B, SUITE G Aptos, California, 95003 PHONE: (831) 786-0373 FAX: (831) 786-8523 EMAIL: Tpinkerton@fehrengineering.com
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FE JOB No. 17055.00

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City of Morgan Hill

Public Works Department 1171 HOMEST SANTA CL 100 Edes Ct. Morgan Hill, CA 95037 (408)778-6480, Fax (408)779-7236 (408) 246-4848

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SANTA CLARA, CA 95050	3
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LIFT	STAT	ION V	٧
SINGLE	LINE	DIAG	RAM

○ SHEET NOTES

CONNECTION.

CONNECTION.

2. 120V CIRCUIT TO CONTROL SECTION.

4. PEDESTAL LIGHTS AND HEATERS.

3. 120V CIRCUIT TO DEGREASER SECTION.

5. POWER CONDUCTORS & MINI CAS SIGNAL CONDUCTORS.

ONE CIRCUIT BREAKER CLOSED SIMULTANEOUSLY.

POWER CONDUCTOR # MINI CAS SIGNAL CONDUCTORS.

8. SIGNAL CONDUCTORS TO MINI CAS CONTROLS.

II. MOMENTARY CONTACT TEST SWITCH.

APPROVAL PRIOR TO PURCHASE.

EQUAL; PROVIDE SUBMITTAL.

15. AREA LIGHTING CONTROLS; DETAIL 1/E3.3.

6. PROVIDE 3 SPARE CIRCUIT BREAKERS; SIZE AS INDICATED.

I. PROVIDE OVERLOAD INDICATING LAMP ADJACENT TO PUMP RUNNING

7. MANUAL TRANSFER SWITCH; INTERLOCKED CIRCUIT BREAKERS; ONLY

9. PUMP CABLES PROVIDED AS PART OF PUMPS; COORDINATE EXACT

10. CONDUIT FOR FLOAT SWITCH CABLES; ELECTRICAL CONTRACTOR

SHALL PROVIDE & INSTALL CABLES AS REQUIRED FOR SIGNAL

12. ELECTRICAL CONTRACTOR SHALL COORDINATE WITH PG&E FOR ALL

14. POWER MONITOR PROVIDED WITH CURRENT TRANSFORMERS (CT); MONITORS VOLTAGE # CURRENT LEVELS; PROVIDE SIGNAL TO PLC FOR 30 DAY LOAD PROFILING WITH SCADA ALARM FOR 30 DAY HIGH # LOW KW READING; ELECTRO INDUSTRIES/GAUGE TECH SHARK OR

16. CONDUIT FOR ULTRASONIC SIGNAL CABLE; ELECTRICAL CONTRACTOR SHALL PROVIDE & INSTALL CABLES AS REQUIRED FOR SIGNAL

17. CONDUIT & CONDUCTOR FOR FLOAT SWITCH SIGNAL CONNECTION;

18. RATE PEDESTAL ELEMENTS TO WITHSTAND FAULT CURRENT NOTED.


SPLICE CONDUCTORS IN PULLBOX; SEE DETAIL 1/E2.4.

13. GENERATOR PLUG MOUNTED TO PEDESTAL ENCLOSURE; PROVIDE WITH ANGLE ADAPTER 240V, 3¢, 4 WIRE; RUSSELLSTOLL MAXGARD (PART NUMBER DS2407 MR000); PROVIDE MATERIAL SUBMITTAL FOR CITY

UTILITY RELATED WORK PRIOR TO BEGINNING PROJECT INSTALLATION.

LENGTH OF CABLES WITH PUMP VENDOR; CABLES INCLUDE PUMP

SANITARY SEWER LIFT STATIONS SHEET NUMBER: E3.1 J & W REHABILITATION

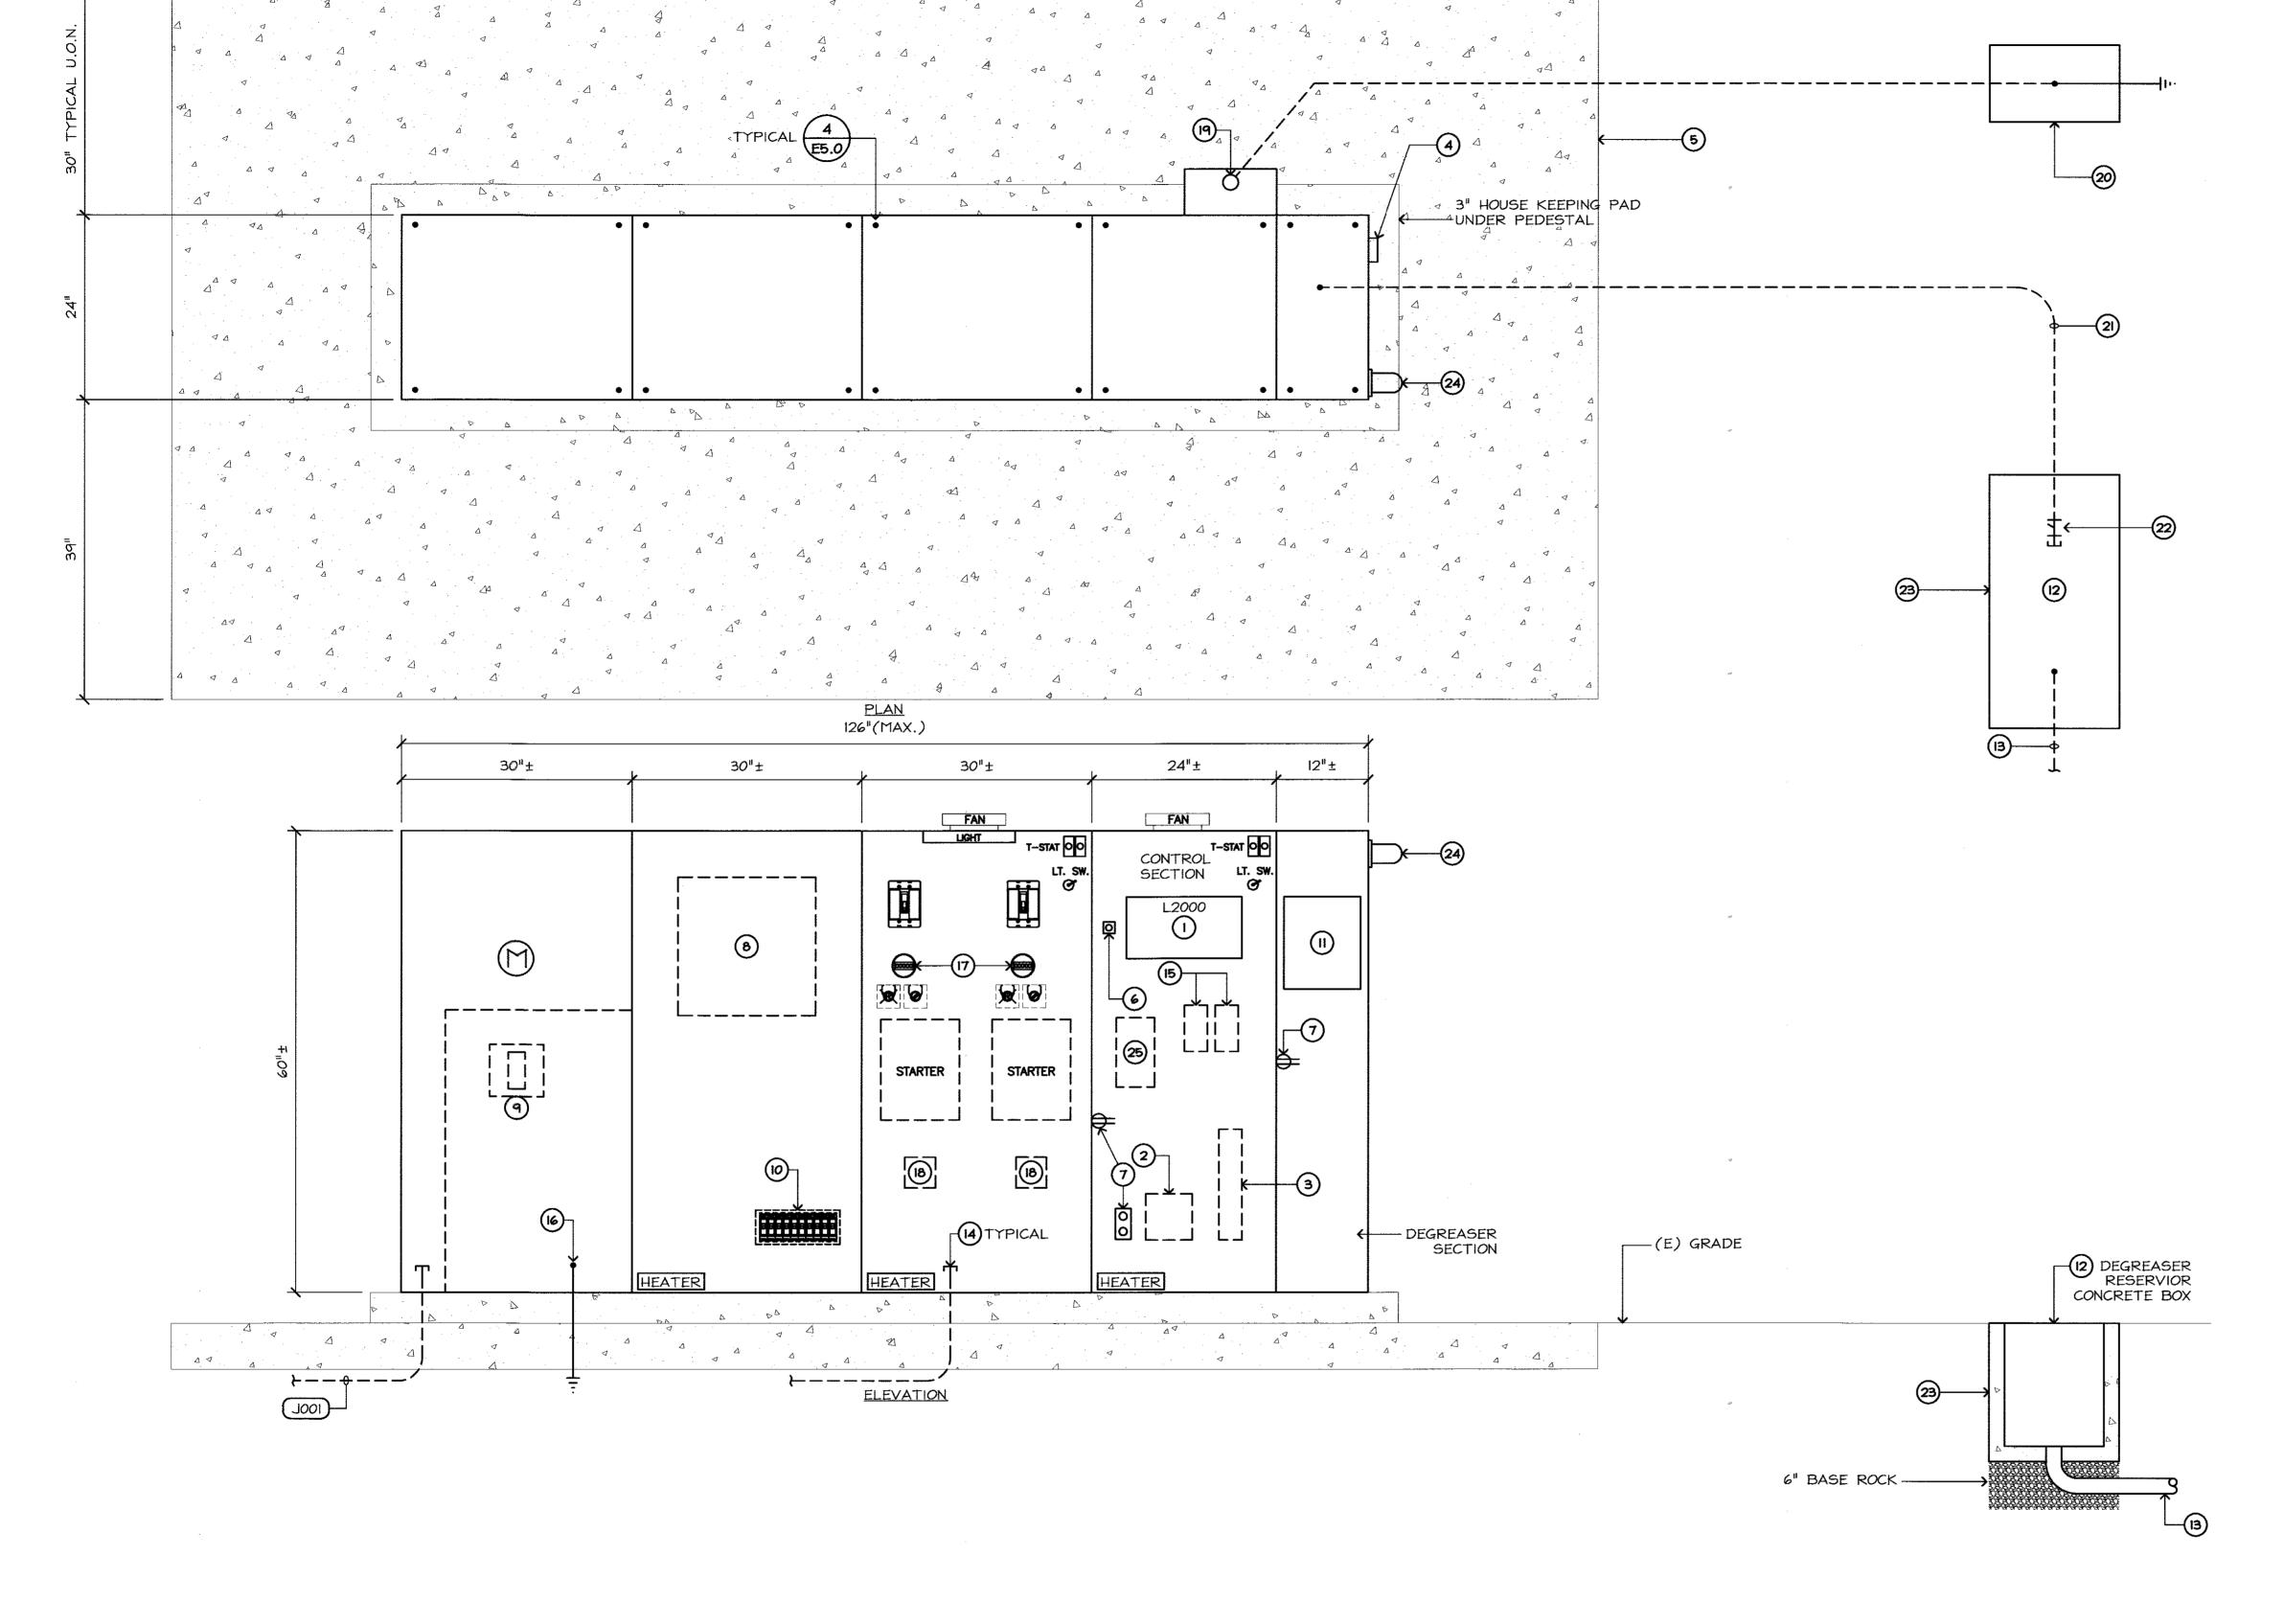

DETAIL NOTES:

- I. CONTROL PLC; TESCO; MOUNTED IN COMPARTMENT INNER DOOR.
- SCADA RADIO GENERAL ELECTRIC MODEL MDS-SDA; PROVIDE SUBMITTAL INCLUDING COMPLETE WIRING DIAGRAM PRIOR TO PURCHASE.
- 3. CONTROL SYSTEM UPS; 120V; WITH CAPACITY TO OPERATE CONTROLS AND COMMUNICATIONS SYSTEMS FOR 2 HOURS AT FULL LOAD.
- SIGNAL HORN GENERAL ALARM SUSTAINED TONE; 100dba AT 10'; 120V; MOUNTED TO PEDESTAL; 200' RANGE; FEDERAL SIGNAL CORP., VIBRATONE MODEL 350 OR EQUAL.
- 5. CONCRETE EQUIPMENT PAD PROVIDED UNDER CIVIL PLANS; APPROXIMATE LAYOUT SHOWN; COORDINATE WITH CIVIL PLANS FOR EXACT PAD SIZE; PAD SIZE SHALL BE BASED UPON POWER PEDESTAL DIMENSIONS.
- 6. ALARM ACKNOWLEDGE MOMENTARY CONTACT PUSHBUTTON; MOUNTED IN COMPARTMENT INNER DOOR.
- 7. COMPARTMENT CONVENIENCE RECEPTACLE.
- 8. AUTOMATIC TRANSFER SWITCH DESIGNED TO TRANSFER LOADS FROM ONE POWER SUPPLY TO ANOTHER; 240V, 100A, 3¢ RATED; INSTALLED IN PEDESTAL ENCLOSURE.
- 9. MAIN CIRCUIT BREAKER.
- 10. STATION CIRCUIT BREAKERS; SEE SINGLE LINE DIAGRAM.
- II. DEGREASER PUMP; "WATCH DOG II" DISPENSER BY ZEP EQUIPMENT; NO SUBSTITUTE PROVIDE SUBMITTAL FOR APPROVAL PRIOR TO PURCHASE; COORDINATE WITH CITY TO SET PUMP TIMES AND RUN DURATION.
- 12. DEGREASER RESERVOIR; CONCRETE PULLBOX 17" X 30" ID; 18" DEEP.
- 13. 2" CONDUIT FOR DEGREASER INJECTION TUBE; SEE STATION PLAN; LOCATE CONDUIT AT LOWEST POINT IN BOX TO AID IN DRAINAGE.
- 14. PROVIDE EYS SEALS FOR ALL CONDUITS INTO THE PEDESTAL FROM THE WET WELL; SEE PLANS FOR EXACT CONDUIT COUNTS & REQUIREMENTS.
- 15. MINI CAS MOISTURE & TEMPERATURE CONTROLS.
- 16. SERVICE GROUND; DRIVEN GROUND ROD; 96" EARTH TO ROD CONTACT; 6"
 ABOVE FINISHED CONCRETE; AWG#6 GROUND ROD BONDED TO CONCRETE
- 17. INDICATING LIGHT \$ INSTRUMENTATION FOR MOTOR STARTER; SEE DETAIL 1/E4.0.
- 18. FLOAT SWITCH INTRINSICALLY SAFE RELAY.
- 19. ANTENNA MAST MOUNTED TO REAR OF CONTROL SECTION; SEE DETAIL 3/E5.0.
- 20. ANTENNA GROUND; 3/4" DIAMETER COPPER GROUND ROD WITH 72" MINIMUM EARTH CONTACT; PROVIDE ACCESS TO GROUND ROD VIA 17"X10" ID CONCRETE BOX CHRISTY N9; SEE DETAIL **3/E5.0**; BOND ANTENNA GROUND TO SYSTEM GROUND VIA 1#6 B.C. CONDUCTOR.
- 21. 2" CONDUIT FOR DEGREASER SUCTION AND INJECTION TUBES.
- 22. EYS SEAL.
- 23. SEE PLANS FOR EXACT BOX LOCATION; COORDINATE WITH CIVIL PLANS.
- 24. HIGH WATER SIGNAL LIGHT; RED FLASHING (90± FLASHES PER MINUTE) LED; 120V; DAYLIGHT VISIBLE FROM 100' MINIMUM; (AS VIEWED FROM THE SIDE OF THE LIGHT); SEE 1/E4.0 FOR CONTROLS.
- 25. LIGHT CONTROLS FOR AREA LIGHT; ASTRONOMIC TIME SWITCH; WITH 24 DAY HOLIDAY SCHEDULE; MANUAL OVERRIDE; DUAL CHANNELS; PANEL MOUNTED FLUSH; TORK DZS SERIES OR APPROVED EQUAL.

LIFT STATION J POWER PEDESTAL

NO SCALE

DATE

DESCRIPTION

PATH

BY

REVISIONS

WORK ACCEPTED: INSPECTOR:

AS-BUILT CORRECTIONS

AS SHOWN
VERT:
AS SHOWN
JOB NUMBER:
MHIL.21.15

HOR:
CITY OF MORGAN HILL
100 Edes Ct.

T.P.

C.L.

CITYENGR SCOTT CREER

CHECKED:

APPROVED:


City of Morgan Hill
Public Works Department

100 Edes Ct. Morgan Hill, CA 95037 (408)778-6480, Fax (408)779-7236

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CONSULTING ELECTRICAL ENGINEERS
FE JOB No. 17055.00

FILE NUMBER:
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FEHR ENGINEERING COMPANY, INC.

9057 SOQUEL DRIVE,

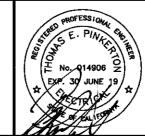
PRINT DATE: 2/16/2018

SANITARY SEWER LIFT STATIONS
J & W REHABILITATION

PRINT DATE: 2/16/2018

SHEET NUMBER: E3.2

21 of 25

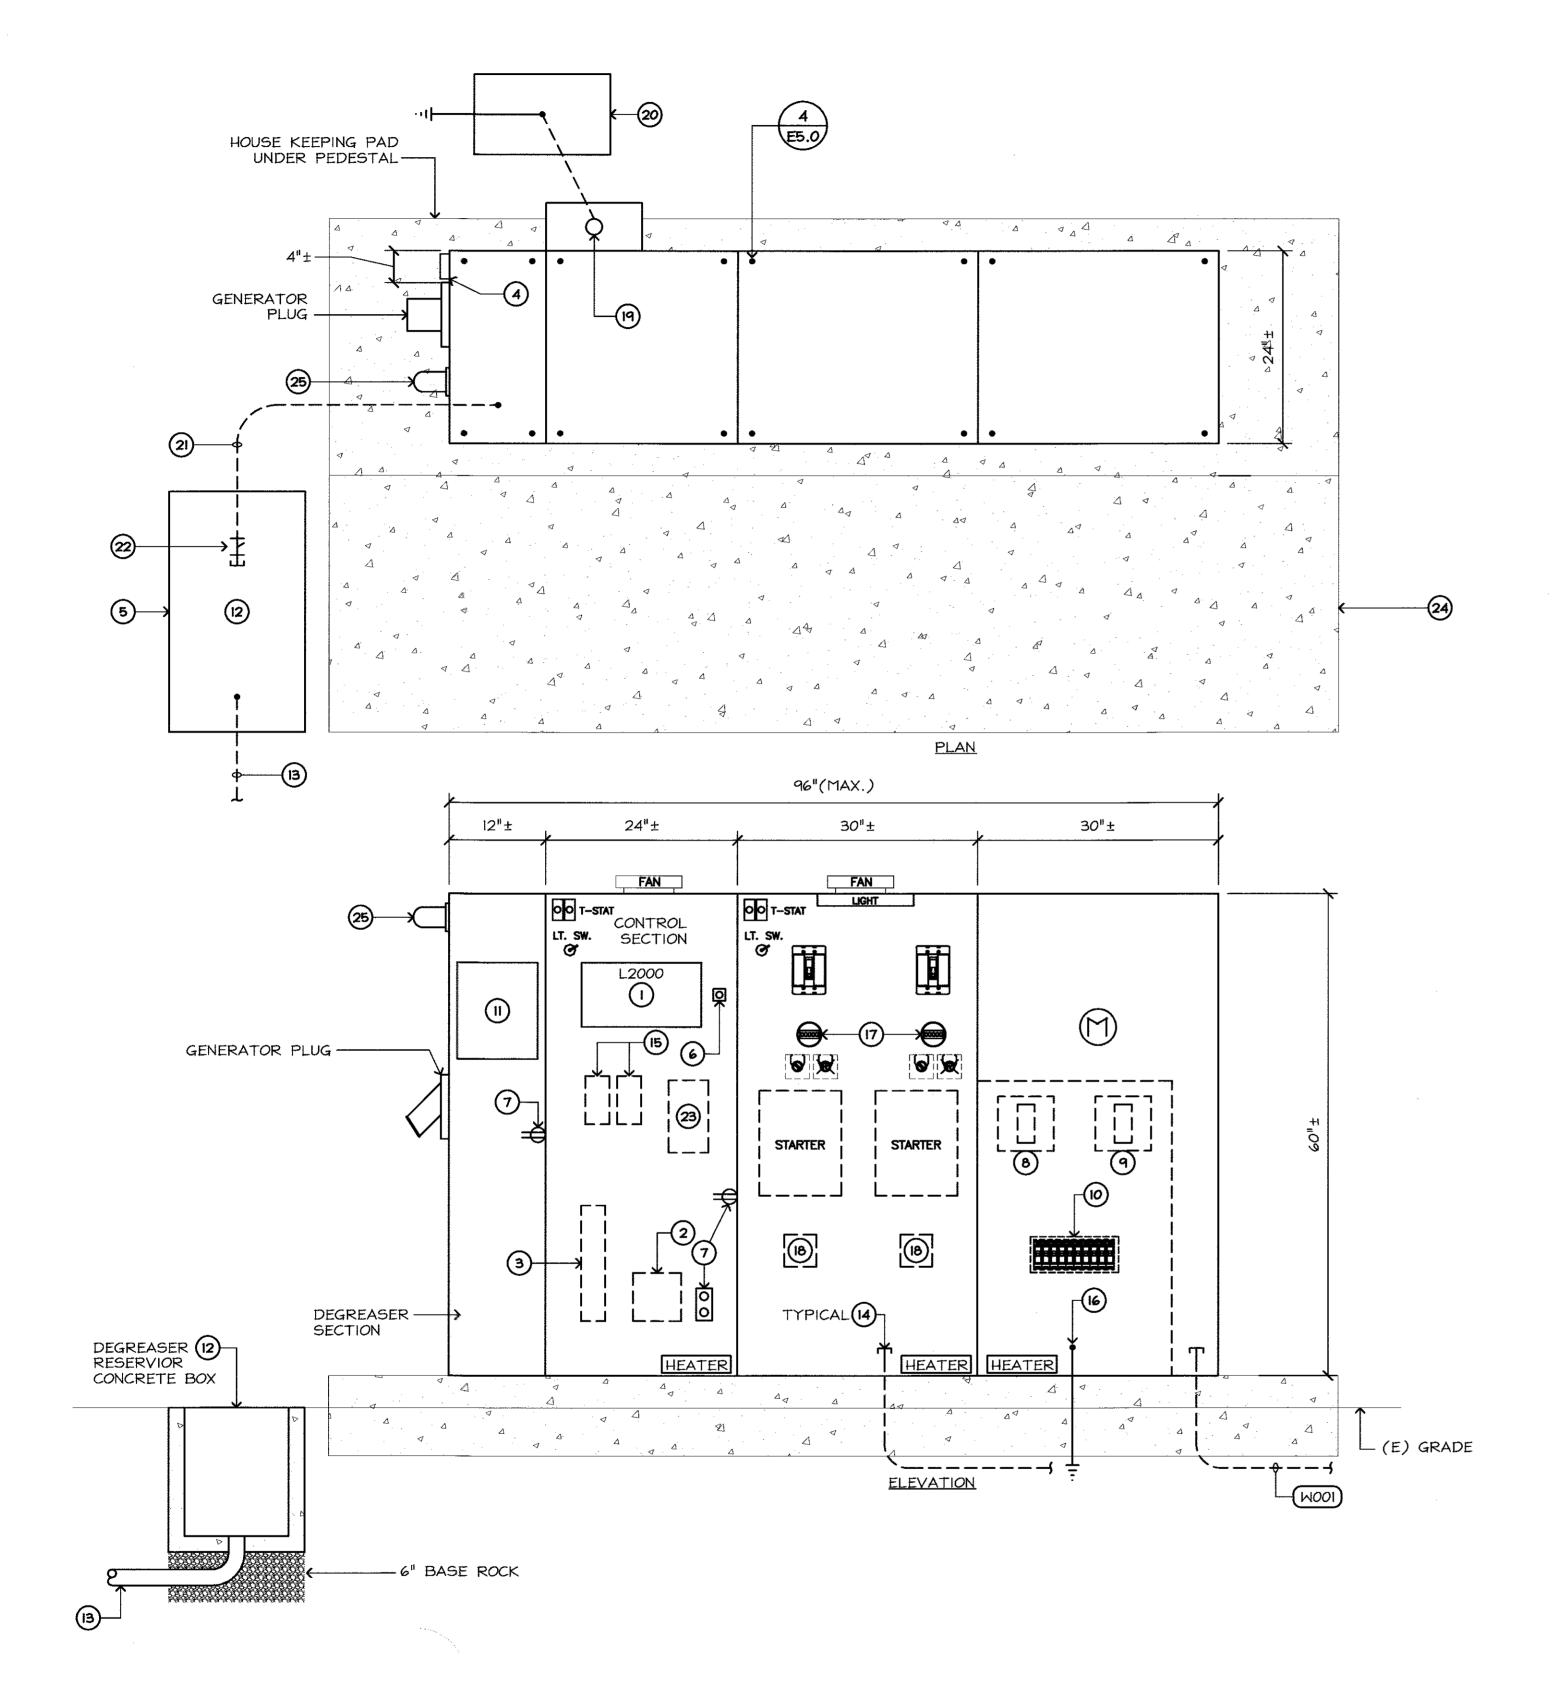

DETAIL NOTES:

- I. CONTROL PLC; TESCO; MOUNTED IN COMPARTMENT INNER DOOR.
- 2. MOUNTING SPACE FOR CITY PROVIDED & INSTALLED SCADA RADIO MDS 4710; COORDINATE REQUIREMENTS WITH THE CITY.
- 3. CONTROL SYSTEM UPS; 120V; WITH CAPACITY TO OPERATE CONTROLS AND COMMUNICATIONS SYSTEMS FOR 2 HOURS AT FULL LOAD.
- 4. SIGNAL HORN GENERAL ALARM SUSTAINED TONE; 100dba AT 101; 120V; MOUNTED TO PEDESTAL; 2001 RANGE; FEDERAL SIGNAL CORP., VIBRATONE MODEL 350 OR EQUAL.
- 5. SEE PLANS FOR EXACT BOX LOCATION; COORDINATE WITH CIVIL PLANS.
- 6. ALARM ACKNOWLEDGE MOMENTARY CONTACT PUSHBUTTON; MOUNTED IN COMPARTMENT INNER DOOR.
- 7. COMPARTMENT CONVENIENCE RECEPTACLE.
- 8. MANUAL TRANSFER SWITCH DESIGNED TO MANUALLY TRANSFER LOADS FROM ONE POWER SUPPLY TO ANOTHER; 240V, 100A, 3¢ RATED; INSTALLED IN PEDESTAL ENCLOSURE; PROVIDE INTERLOCKING CIRCUIT BREAKERS.
- 9. MAIN CIRCUIT BREAKER.
- 10. STATION CIRCUIT BREAKERS; SEE SINGLE LINE DIAGRAM.
- II. DEGREASER PUMP; "WATCH DOG II" DISPENSER BY ZEP EQUIPMENT; NO SUBSTITUTE PROVIDE SUBMITTAL FOR APPROVAL PRIOR TO PURCHASE; COORDINATE WITH CITY TO SET PUMP TIMES AND RUN DURATION.
- 12. DEGREASER RESERVOIR; CONCRETE PULLBOX 17" X 30" ID; 18" DEEP.
- 13. 2" CONDUIT FOR DEGREASER INJECTION TUBE; SEE STATION PLAN; LOCATE CONDUIT AT LOWEST POINT IN BOX TO AID IN DRAINAGE.
- 14. CONDUITS INTO THE PEDESTAL FROM THE WET WELL; SEE PLANS FOR EXACT CONDUIT COUNTS & REQUIREMENTS.
- 15. MINI CAS MOISTURE & TEMPERATURE CONTROLS.
- 16. SERVICE GROUND; DRIVEN GROUND ROD; 96" EARTH TO ROD CONTACT; 6" ABOVE FINISHED CONCRETE; AWG#6 GROUND ROD BONDED TO CONCRETE REBAR.
- 17. INDICATING LIGHT \$ INSTRUMENTATION FOR MOTOR STARTER; SEE MOTOR STARTER DIAGRAM.
- 18. FLOAT SWITCH INTRINSICALLY SAFE RELAY.
- 19. ANTENNA MAST MOUNTED TO REAR OF CONTROL SECTION; SEE DETAIL 3/E5.0.
- 20. ANTENNA GROUND; 3/4" DIAMETER COPPER GROUND ROD WITH 72" MINIMUM EARTH CONTACT; PROVIDE ACCESS TO GROUND ROD VIA 17"X10" ID CONCRETE BOX CHRISTY N9; SEE DETAIL 3/E5.0; BOND ANTENNA GROUND TO SYSTEM GROUND VIA 1#6 B.C. CONDUCTOR.
- 21. 2" CONDUIT FOR DEGREASER INJECTION TUBE.
- 22. EYS SEAL.
- 23. LIGHT CONTROLS FOR AREA LIGHT; ASTRONOMIC TIME SWITCH; WITH 24 DAY HOLIDAY SCHEDULE; MANUAL OVERRIDE; DUAL CHANNELS; PANEL MOUNTED FLUSH; TORK DZS SERIES OR APPROVED EQUAL.
- 24. CONCRETE EQUIPMENT PAD PROVIDED UNDER CIVIL PLANS; APPROXIMATE LAYOUT SHOWN; COORDINATE WITH CIVIL PLANS FOR EXACT PAD SIZE; PAD SIZE SHALL BE BASED UPON POWER PEDESTAL DIMENSIONS.
- 25. HIGH WATER SIGNAL LIGHT; RED FLASHING (90 + FLASHES PER MINUTE) LED; 120V; DAYLIGHT VISIBLE FROM 100' MINIMUM; (AS VIEWED FROM THE SIDE OF THE LIGHT); SEE 1/E4.1 FOR CONTROLS.

LIFT STATION W POWER PEDESTAL


FEHR ENGINEERING COMPANY, INC. 9057 SOQUEL DRIVE, BLDG. B, SUITE G
Aptos, California, 95003
PHONE: (831) 786–0373
FAX: (831) 786–8523
EMAIL: Tpinkerton@fehrengineering.com
CONSULTING ELECTRICAL ENGINEERS
FE JOB No. 17055.00

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PATH				REVISIONS		CITYENGR SCOTT CREER		



Schaaf & Wheeler City of Morgan Hill **Public Works Department**

CONSULTING CIVIL ENGINEERS 1171 HOMESTEAD ROAD, STE 255 SANTA CLARA, CA 95050 (408) 246-4848

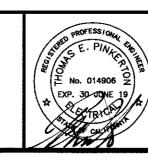


LIFT STATION W **POWER PEDESTAL** SANITARY SEWER LIFT STATIONS J & W REHABILITATION

SHEET NUMBER: E3.3 22 of 25

FILE NUMBER


PRINT DATE:

2/16/2018

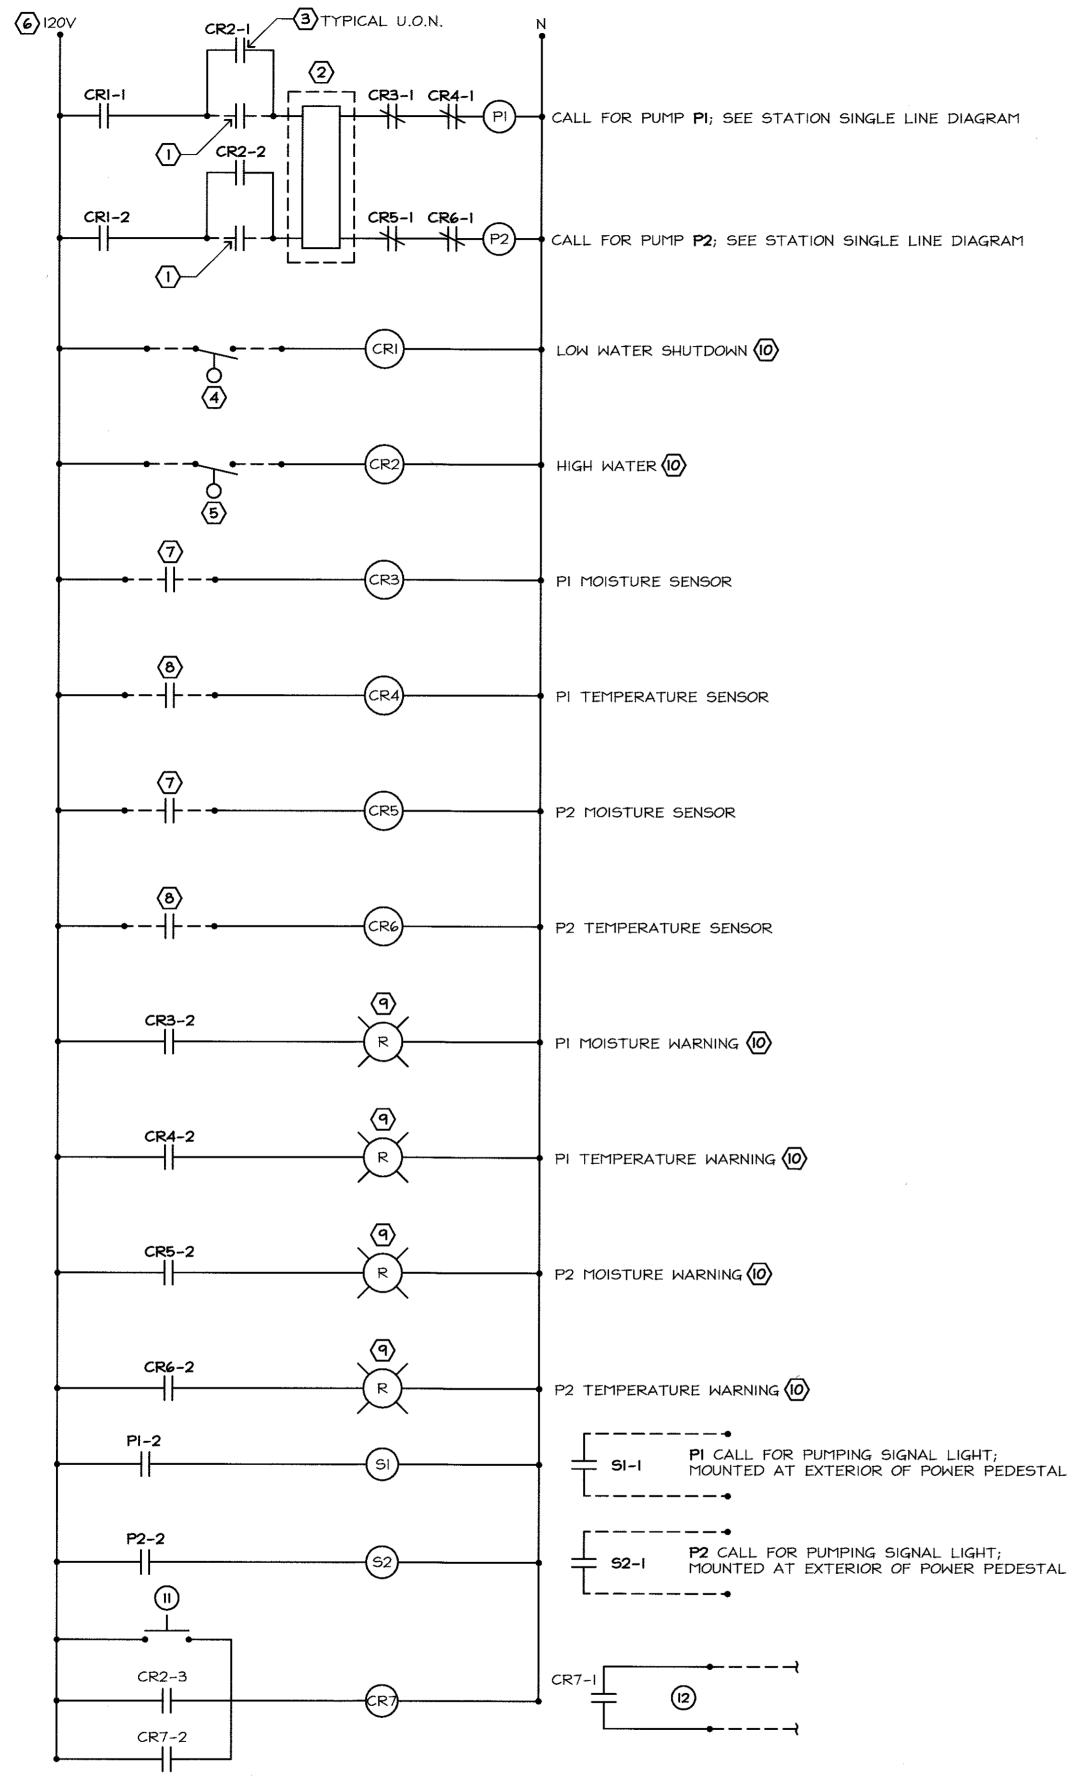

LIFT STATION J SCHEMATIC PUMP CONTROL DIAGRAM NO SCALE

CHECKED: AS-BUILT CORRECTIONS APPROVED: NO. DATE DESCRIPTION BY DATE: PATH **REVISIONS**

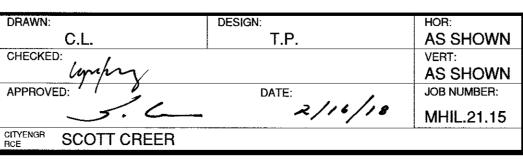

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City of Morgan Hill **Public Works Department**

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(408) 246-4848

9057 SOQUEL DRIVE, BLDG. B, SUITE G Aptos, California, 95003 PHONE: (831) 786-0373 FAX: (831) 786-8523 EMAIL: Tpinkerton@fehrengineering.com CONSULTING ELECTRICAL ENGINEERS FE JOB No. 17055.00 LIFT STATION J SCHEMATIC PUMP

CONTROL DIAGRAM PRINT DATE: SANITARY SEWER LIFT STATIONS J & W REHABILITATION

○ SHEET NOTES

INDIVIDUAL PUMP STARTS.

UPON HIGH WATER CONDITION.

SINGLE LINE DIAGRAM.

ON CONTROL DIAGRAM.

BUTTON.

DETAIL 1/E3.2.

10. SENDS SCADA SIGNAL/ALARM.

LEVEL.

I. FROM N.O. CONTACTS OF ULTRASONIC LEVEL CONTROL; CONTACT

2. PUMP ALTERNATOR; ROTATES START SEQUENCE OF PUMPS; (LEAD PUMP, LAG PUMP); PROVIDE TIME DELAY OF 60 SECONDS BETWEEN

4. FSI; LOW WATER FLOAT SWITCH; STOPS ALL PUMPING AT LOW WATER

5. FS2; HIGH WATER FLOAT SWITCH; CALLS FOR ALL PUMPS TO START

6. CONTROL POWER PROVIDED FROM PEDESTAL CIRCUITS VIA UPS; SEE

PART OF PUMPS WITH CONTROLLER INSTALLED IN POWER PEDESTAL

8. TEMPERATURE SENSOR RELAY FROM MINI CAS SYSTEM; PROVIDED AS PART OF PUMPS WITH CONTROLLER INSTALLED IN POWER PEDESTAL

9. I"+ DIAMETER RED LENS INDICATING LAMP; MOUNTED TO EXTERIOR

11. PEDESTAL MOUNTED MOMENTARY CONTACT LAMP TEST PUSH

12. HIGH WATER SIGNAL LIGHT \$ HORN MOUNTED TO PEDESTAL SEE

DOOR OF POWER PEDESTAL CONTROL SECTION; LABEL AS INDICATED

7. MOISTURE SENSOR RELAY FROM MINI CAS SYSTEM; PROVIDED AS

3. CONTROL RELAY; DPDT, 8 PIN RELAY; 10 AMP CONTACTS.


CONTROL SECTION BY ELECTRICAL CONTRACTOR.

CONTROL SECTION BY ELECTRICAL CONTRACTOR.

CLOSES UPON REACHING PUMPING LEVEL & REMAINS CLOSED UNTIL REACHING STOP LEVEL; SEE CIVIL PLANS FOR PUMPING LEVELS.

> 2/16/2018 SHEET NUMBER: **E4.0** 23 of 25

FEHR ENGINEERING COMPANY, INC.

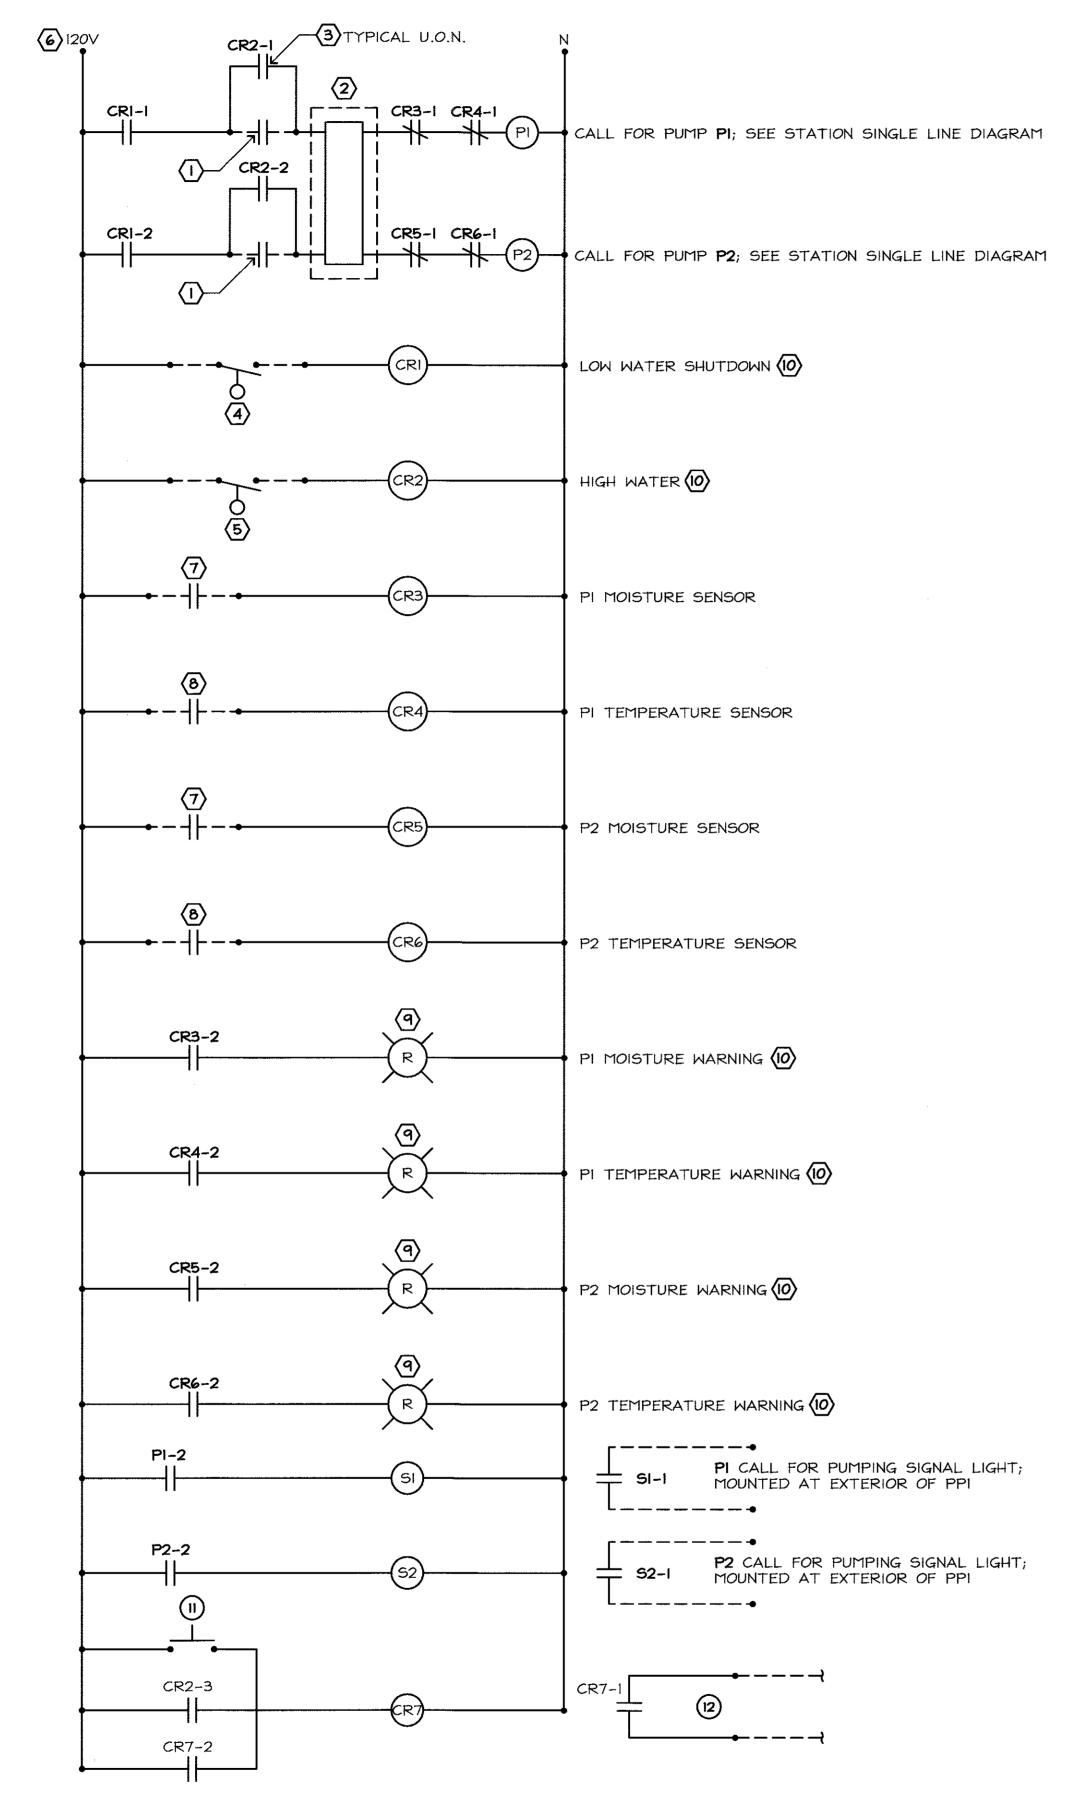

LIFT STATION W SCHEMATIC PUMP CONTROL DIAGRAM NO SCALE

WORK ACCEPTED: INSPECTOR:

REVISIONS

DATE

DESCRIPTION

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AS-BUILT CORRECTIONS

DATE:

AS SHOWN AS SHOWN JOB NUMBER: CITY OF MORGAN HILL 2/16/18 MHIL.21.15 100 Edes Ct. Morgan Hill, CA 95037 (408)778-6480, Fax (408)779-7236

T.P.

C.L.

CITYENGR SCOTT CREER

CHECKED:

APPROVED:



NO SCALE

CONSULTING CIVIL ENGINEERS 1171 HOMESTEAD ROAD, STE 255 SANTA CLARA, CA 95050

(408) 246-4848

	90 BLI Ap PHI EMAIL: Tpinkerton	RING COMPANY, INC. 57 SOQUEL DRIVE, DG. B, SUITE G tos, California, 95003 ONE: (831) 786-0373 X: (831) 786-8523 Gefehrengineering.com ECTRICAL ENGINEERS 7055.00
Es.	LIFT STATION W SCHEMATIC PUMP	FILE NUMBER: -
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PRINT DATE: 2/16/2018 SANITARY SEWER LIFT STATIONS SHEET NUMBER: **E4.1** J & W REHABILITATION 24 of 25

FEHR ENGINEERING COMPANY, INC.

CLOSES UPON REACHING PUMPING LEVEL & REMAINS CLOSED UNTIL REACHING STOP LEVEL; SEE CIVIL PLANS FOR PUMPING LEVELS. 2. PUMP ALTERNATOR; ROTATES START SEQUENCE OF PUMPS; (LEAD

I. FROM N.O. CONTACTS OF ULTRASONIC LEVEL CONTROL; CONTACT

INDIVIDUAL PUMP STARTS. 3. CONTROL RELAY; DPDT, 8 PIN RELAY; 10 AMP CONTACTS.

4. FSI; LOW WATER FLOAT SWITCH; STOPS ALL PUMPING AT LOW WATER

PUMP, LAG PUMP); PROVIDE TIME DELAY OF 60 SECONDS BETWEEN

5. FS2; HIGH WATER FLOAT SWITCH; CALLS FOR ALL PUMPS TO START UPON HIGH WATER CONDITION.

6. CONTROL POWER PROVIDED FROM PEDESTAL CIRCUITS; SEE SINGLE LINE DIAGRAM.

7. MOISTURE SENSOR RELAY FROM MINI CAS SYSTEM; PROVIDED AS PART OF PUMPS WITH CONTROLLER INSTALLED IN PPI CONTROL SECTION BY ELECTRICAL CONTRACTOR; SEE DETAIL 1/E3.3 \$ 1/E3.4.

8. TEMPERATURE SENSOR RELAY FROM MINI CAS SYSTEM; PROVIDED AS PART OF PUMPS WITH CONTROLLER INSTALLED IN POWER PEDESTAL CONTROL SECTION BY ELECTRICAL CONTRACTOR.


9. I" + DIAMETER RED LENS INDICATING LAMP; MOUNTED TO EXTERIOR DOOR OF PPI CONTROL SECTION; LABEL AS INDICATED ON CONTROL

10. SENDS SCADA SIGNAL/ALARM.

○ SHEET NOTES


II. PEDESTAL MOUNTED MOMENTARY CONTACT LAMP TEST PUSH


12. HIGH WATER SIGNAL LIGHT & HORN MOUNTED TO PEDESTAL SEE DETAIL I/E3.3.

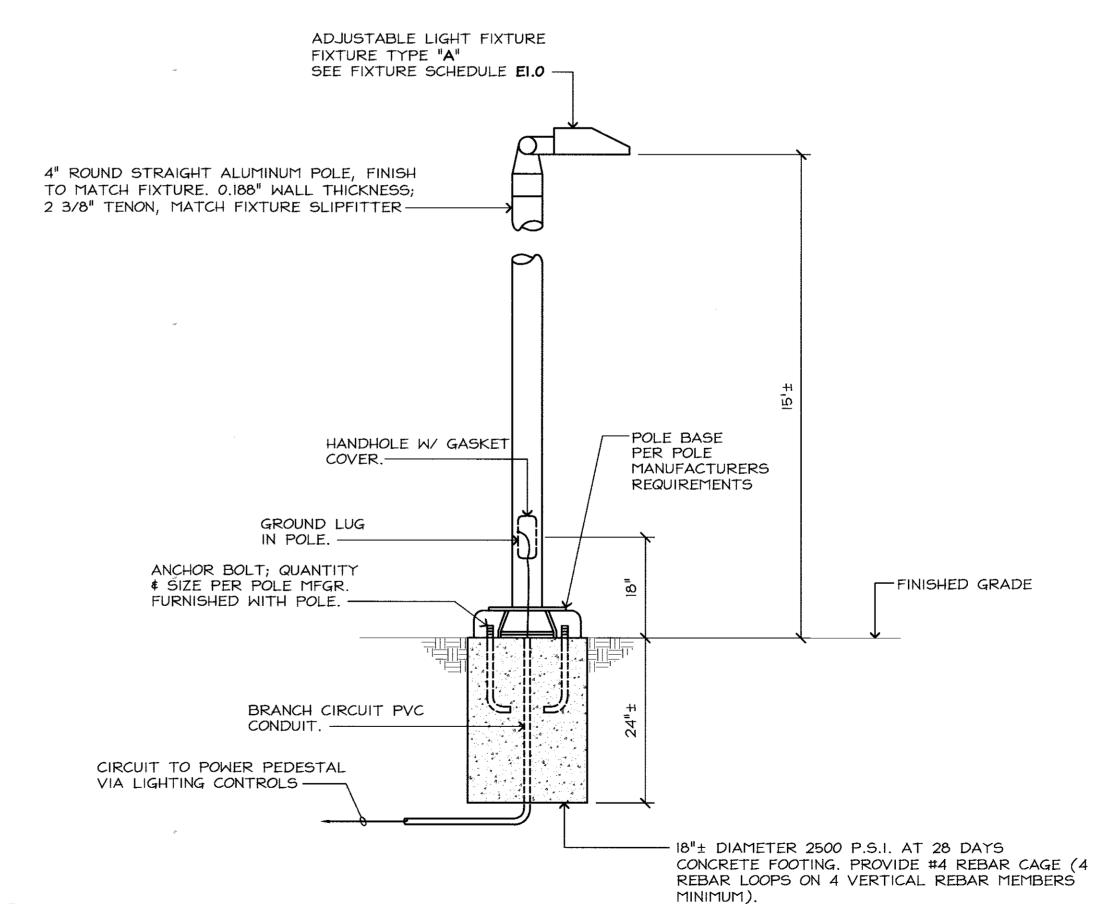



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Schaaf & Wheeler



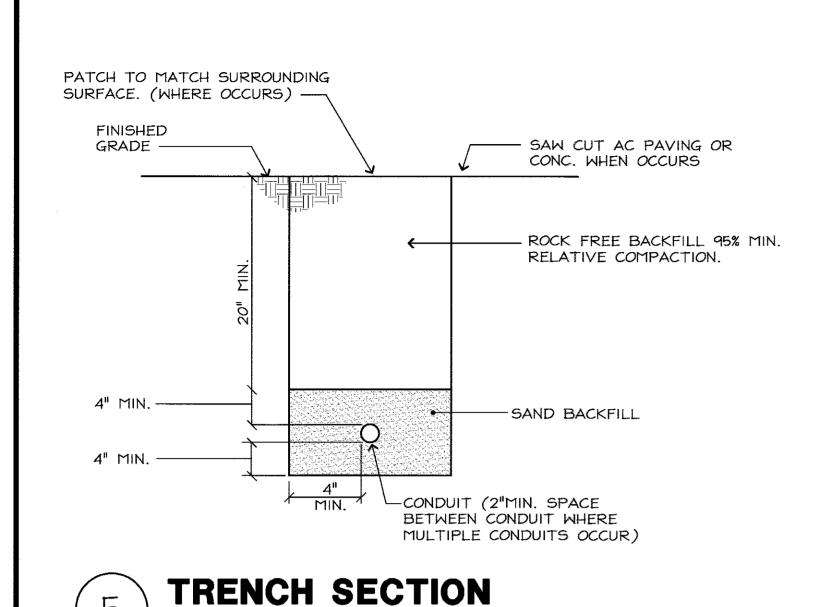


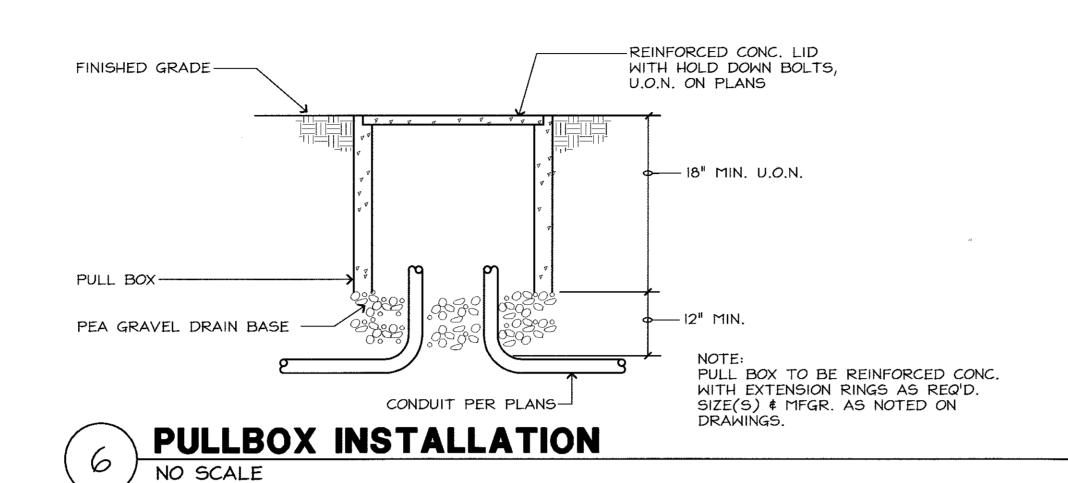


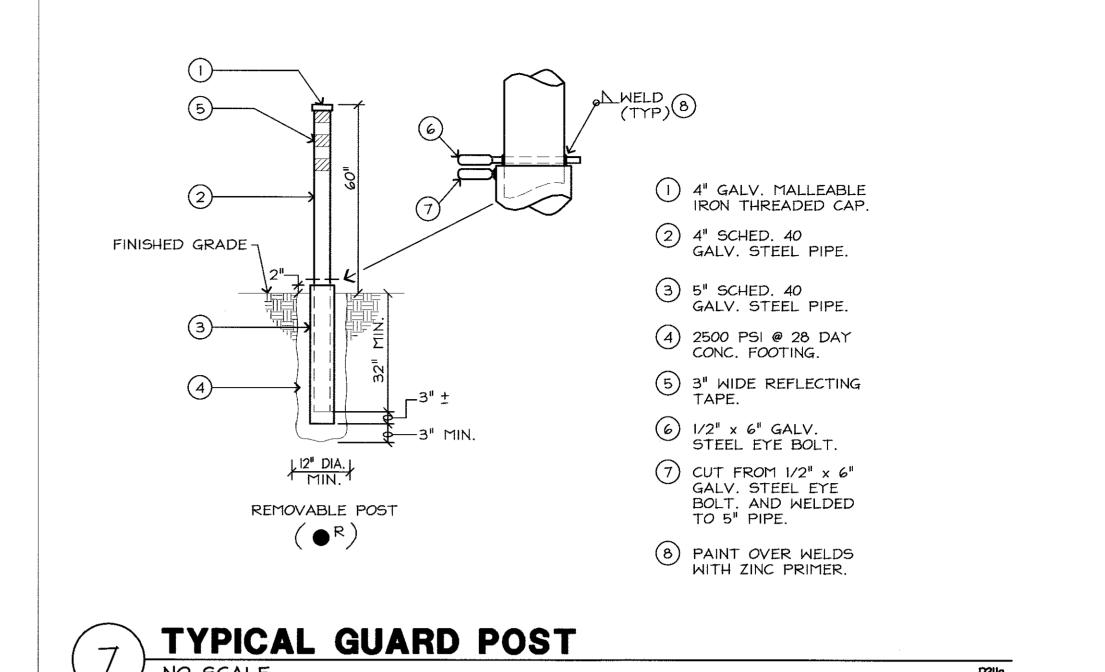


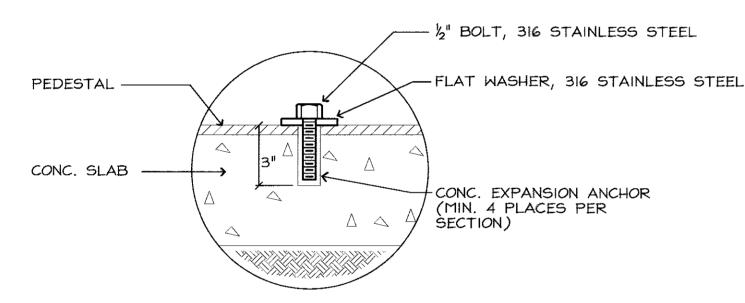4 EQUIPMENT ANCHORING NO SCALE

NO SCALE

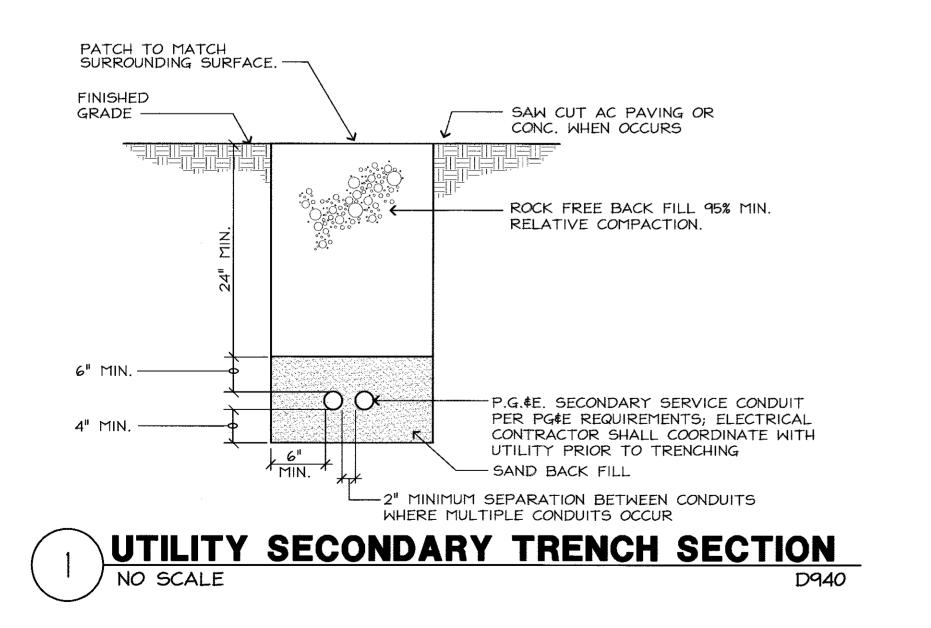

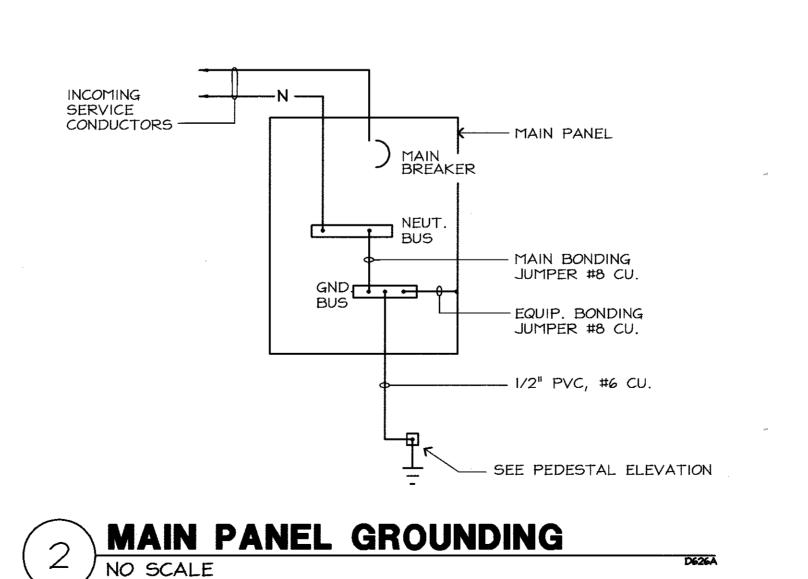

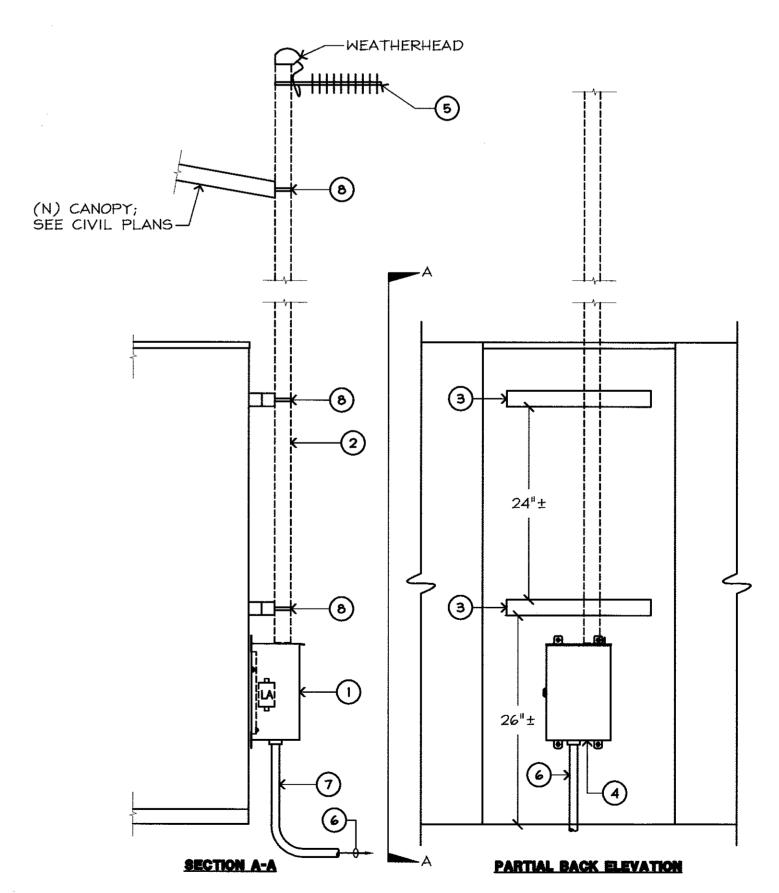

- DETAIL NOTES:
 - 1. JUNCTION BOX; 12" X 8" X 6"D.; NEMA 3R; HINGED COVER WITH STAINLESS STEEL PAD LOCKABLE LATCH; BOLT TO BACK OF PEDESTAL SECTION USING 3/16" DIAMETER (MINIMUM) STAINLESS STEEL BOLTS WITH STAINLESS STEEL HARDWARE 4 PLACES.
 - IO' ANTENNA MAST; 2"C.O.; GRS; CLAMPED TO STRUT TWO PLACES;
 - 3. UNISTRUT WELDED TO ENCLOSURE; I 5/8" X 3 I/4" X I8"; CENTERED ON BACK OF PEDESTAL SECTION; FINISH STRUT TO MATCH PEDESTAL.
 - 4. JUNCTION BOX TO HOUSE ANTENNA CONDUCTOR WITH COAXIAL LIGHTENING ARRESTOR (LA); PROVIDE LA #8 B.C. GROUND CONDUCTOR TO SERVICE GROUND SYSTEM. BOND ANTENNA MAST & JUNCTION BOX.
 - 5. ANTENNA ¢ COAXIAL CONDUCTOR PROVIDED BY CITY, CONTRACTOR SHALL INSTALL.
 - TO ANTENNA GROUND ROD; SEE POWER PEDESTAL ELEVATION.
 - 7. I" GRS C., I#6 B.C. GROUND CONDUCTOR.
 - 8. SECURE ANTENNA MAST AS INDICATED; 2" GRS CLAMP.

2 GNO CLAII.

(3	ANTENNA	MAST
	NO SCALE	

FEHR ENGINEERING COMPANY, INC.

9057 SOQUEL DRIVE,
BLDG. B, SUITE G
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CONSULTING ELECTRICAL ENGINEERS
FE JOB No. 17055.00

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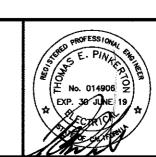
City of Morgan Hill Public Works Department

Public Works Department

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Schaaf & Wheeler
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ANITARY SEWER LIFT STATIONS	
J & W REHABILITATION	

PRINT DATE: 2/16/2018

SHEET NUMBER: **E5.0 25** OF **25**